


MEMBER

BD

CREATIVE CRAFTS COMMERCIAL DEVELOPMENT

& DESIGN, LLC lle, La. 70769-1987 sred1@gmail.com HARRIS DRAFTING & P.O.Box 1987, Prairieville, 225-405-9172 ~ chasre

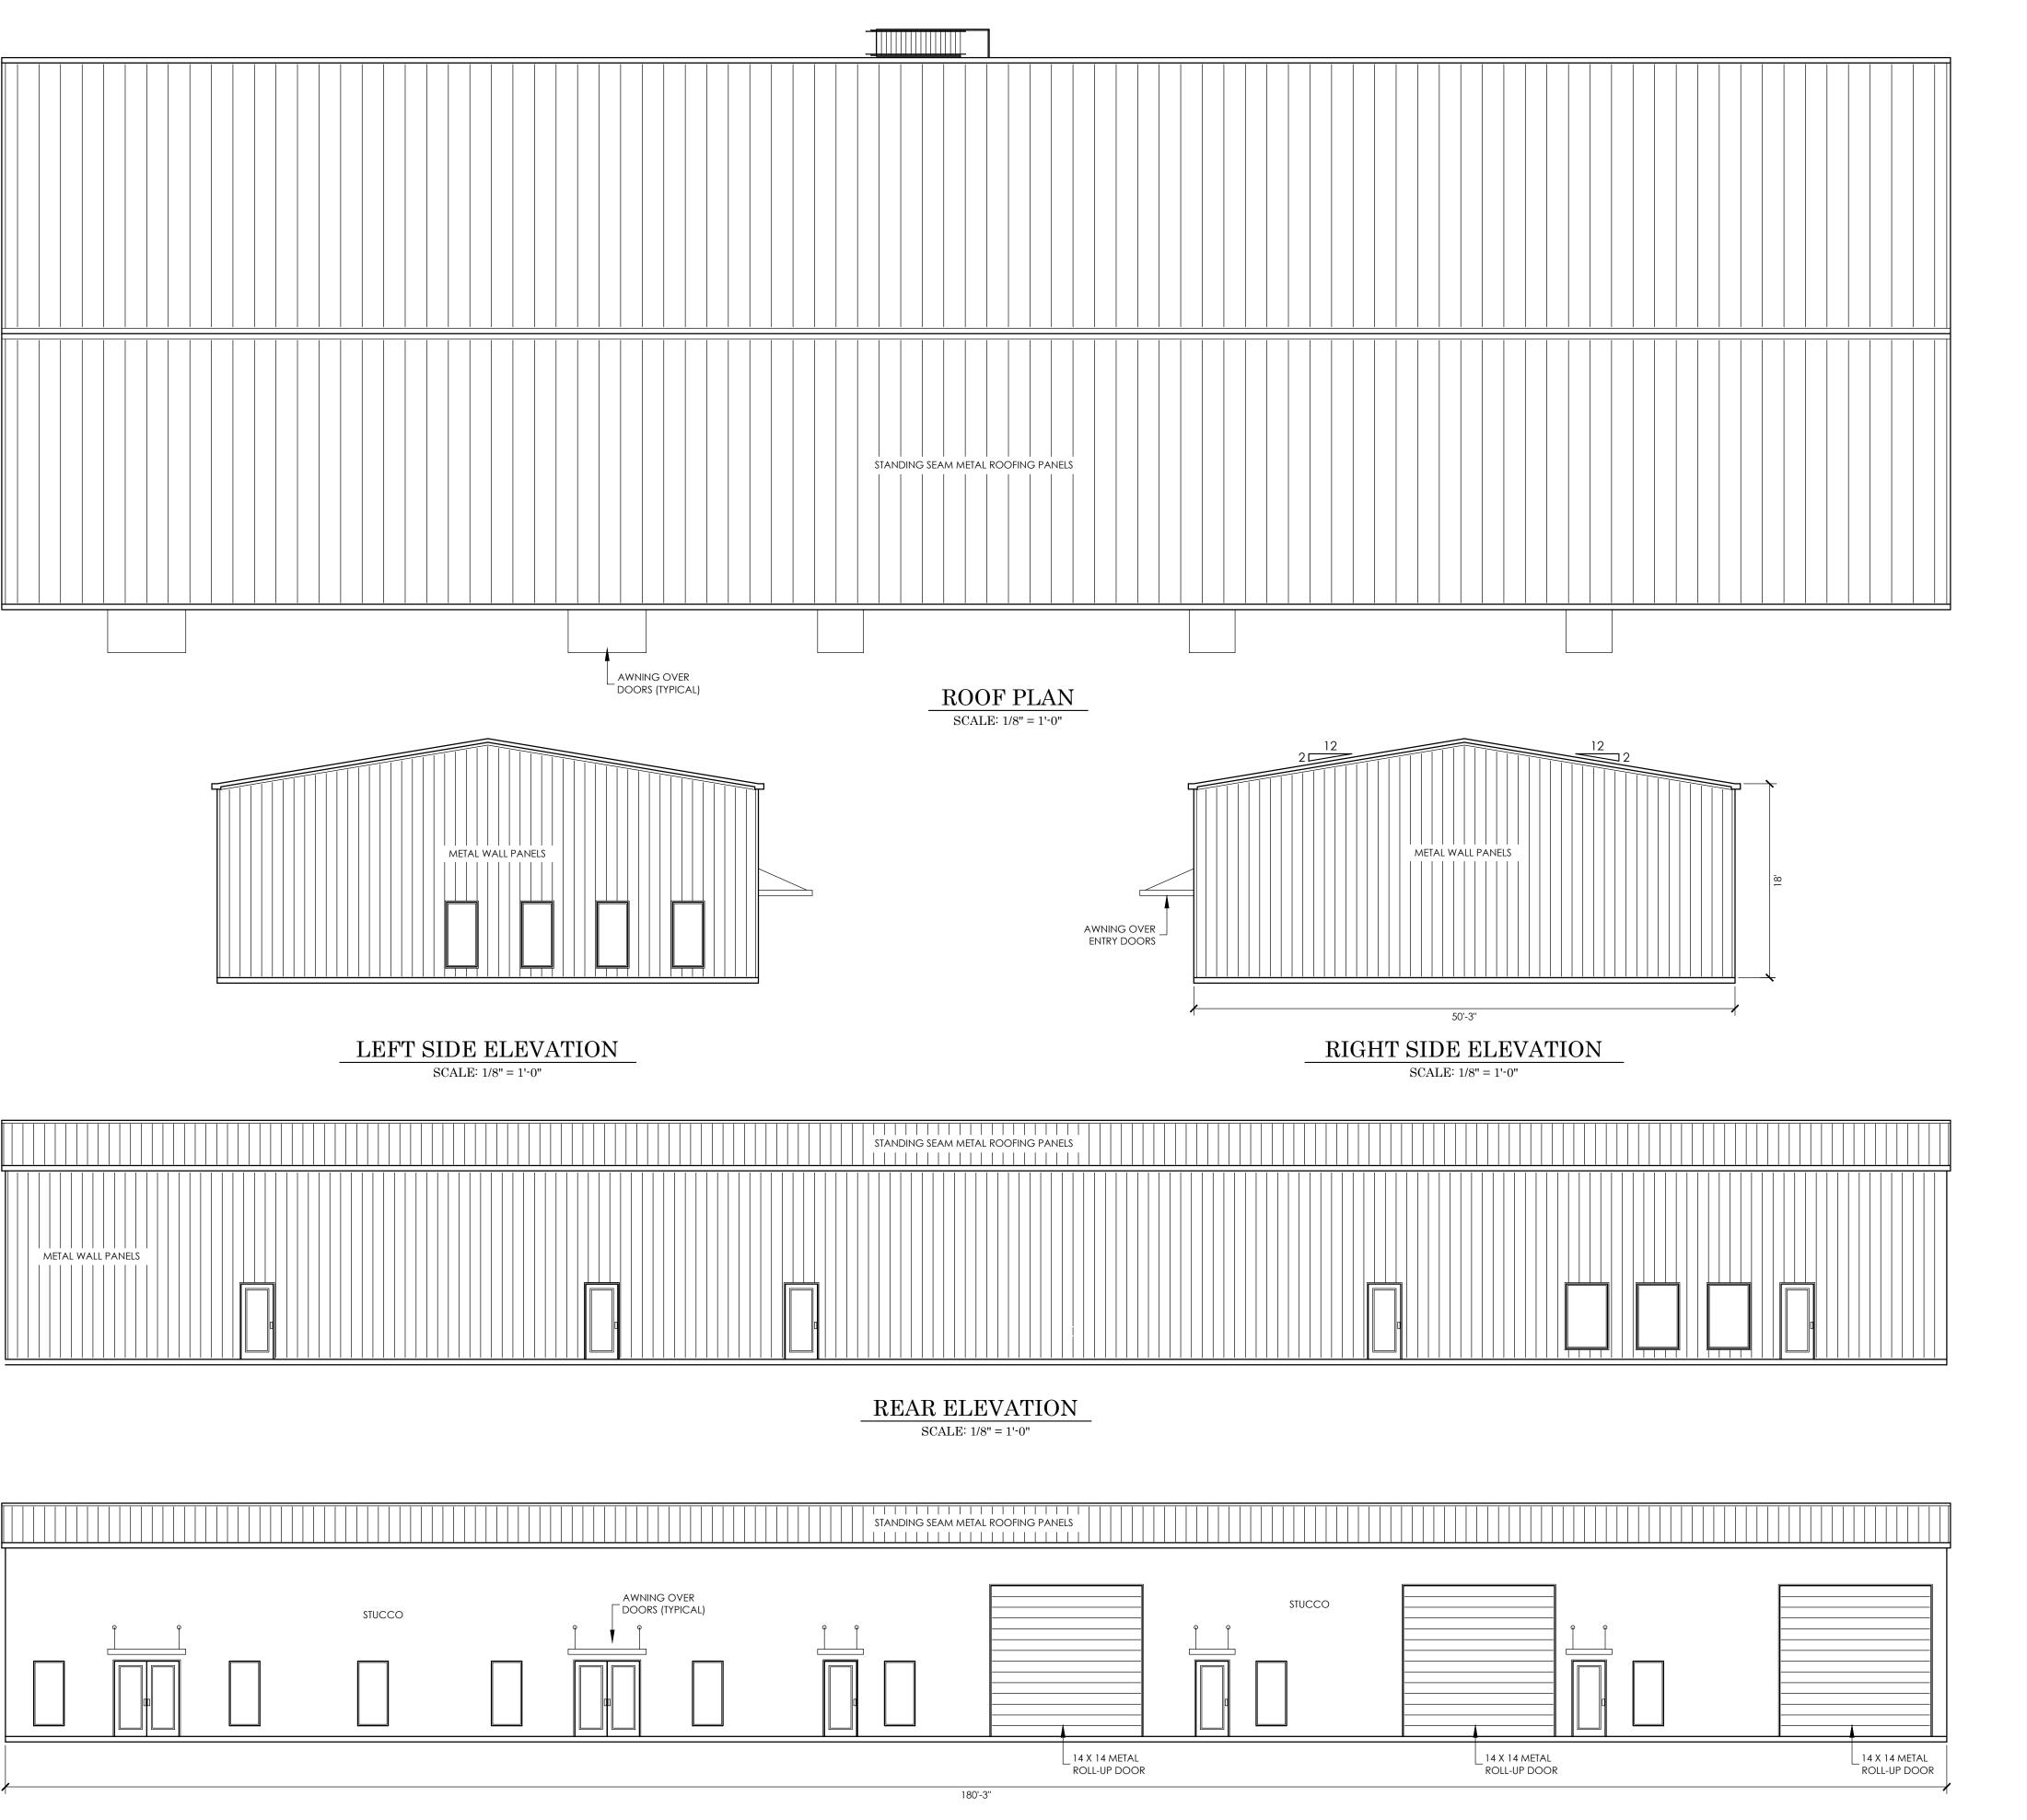

FRONT ELEVATION

SCALE: 1/8" = 1'-0"

REVIEWED FOR
STATE FIRE MARSHAL
STATE FIRE MARSHAL
AS PER REVIEW LETTER
AS PER DICKERSON, ARCHITE
WARREN DICKERSON
AR-20-006715
AR-20-0200



GENERAL NOTES:

- 1. ALL WORK SHALL MEET APPLICABLE REQUIREMENTS OF CITY (INTERNATIONAL BUILDING CODE 2015); STATE (INTERNATIONAL BUILDING CODE 2015) (NFPA 101, 2015) AND PARISH
- 2. THE APPLICABLE REQUIREMENTS OF THE AMERICAN SOCIETY OF HEATING, REFRIGERATING, AND AIR CONDITIONING ENGINEERS AND ILLUMINATING ENGINEERINGSOCIETY OF NORTH AMERICA STANDARD 90.1-(ANSI/ASHRAE/IESNA 90.1-2004) WITH STATE AMENDMENTS AND THE INTERNATIONAL ENERGY CONSERVATION CODE, (SEE DEPT. OF ENERGYS'
- WEBSITE http://www.energycodes.gov.)
 3. LRS 40:1731-(EFFECTIVE 10/01/11) PROVIDE ACCESS FOR PERSONS WITH DISABILITIES IN ACCORDANCE WITH ADA-ABA ACCESSABILITY GUIDELINES, JULY 23, 2004 (ALSO KNOWN AS THE 2010 STANDARDS) AND WITH THE FEDERAL AMERICANS WITH DISABILITIES (CIVIL RIGHTS) ACT OF 1990.
- 4. ELECTRICAL SHALL COMPLY WITH 2015 NFPA 70, NATIONAL ELECTRICAL CODE 2015 FOR STATE OF LOUISIANA AND INTERNATIONAL BUILDING CODE 2015.
- 5. HVAC SYSTEM SHALL BE IN ACCORDANCE WITH NFPA 2015 101.9.2.
- 6. INSTALL SMOKE DETECTORS TO AUTOMATICALLY STOP THE FAN IN HVAC DUCT SYSTEMS
- OVER 200 CFM AS PER NFPA 90A:6.4.2.(1).
 7. EMERGENCY LIGHTING SHALL BE INSTALLED AS PER NFPA 101:7.8 &9.
- 8. EXIT AREAS SHALL BE LIGHTED CONTINUOUSLY WHEN BUILDING IS OPEN DURING NORMAL BUSINESS HOURS. ILLUMINATION SHALL NOT BE LESS THAN ONE FOOT CANDLE, MEASURED AT THE FLOOR. THESE AREAS SHALL CONTINUE TO BE LIGHTED BY OTHER BULBS IN EACH AREA AS PER NFPA 101:7.8.
- 9. EXIT SIGNS SHALL COMPLYI WITH THE NFPA 101:7-10 AND SHALL DEFINE EXITS AND ACCESS TO EXITS WHERE THE EXIT IS NOT IMMEDIATELY APPARENT. PERMANENT SIGNAGE SHALL COMPLY WITH ADA-AG (ACCESSABILITY GUIDELINES, SEPT. 1994) PARAGRAPHS 4.1.3(16) AND 4.30, 4.30.1 THRU 4.30.6.
- 10. 101:9.7.1 NFPA 10:3-2.4;. PORTABLE FIRE EXTINGUISHER SHALL BE PROVIDED IN ACCORDANCE WITH NFPA SECTION 10. DISTRIBUTION OF FIRE EXTINGUISHERS SHALL BE AS PER INDEX "E" OF SECTION 10.
- 11. 101:9.7.4.1 NFPA 10:1-5.10 TOP OF FIRE EXTINGUISHER, HAVING A GROSS WEIGHT LESS THAN 40 LBS., SHALL NOT BE MORE THAN 5 FEET ABOVE THE FLOOR, 3-1/2 FEET IF GROSS WEIGHT IS GREATER THAN 40 LBS.
- 12. NFPA 102.9.7.4.1, NFPA 10:1-6.3. TRAVEL DISTANCE TO A FIRE EXTINGUISHER SHALL NOT EXCEED 75 FEET. FIRE EXTINGUISHER SHALL BE CONSPICUOUSLY LOCATED WHERE IT WILL
- BE READILY ACCESSIBLE AND IMMEDIATELY AVAILABLE.

 13. LRS 40:1664.4 AND 40:1628, ALL WORK AND INSPECTIONS OF FIRE ALARM, FIRE SUPRESSION, AND FIRE EXTINGUISHING SYSTEMS OR PORTABLE FIRE EXTINGUISHERS SHALL BE PERFORMED BY A STATE OF LOUISIANA CERTIFIED AGENT. (APPLY TO LOUISIANA FIRE MARSHALLS'
- OFFICE UNDER SEPERATE PERMIT WHEN REQUIRED.)

 14. 101:7.2.1.5. NO DOOR IN ANY MEANS OF EGRESS SHALL BE LOCKED AGAINST EGRESS
- WHEN THE BUILDING IS OCCUPIED.

 15. 101:12.2.2. DOORS IN A REQUIRED MEANS OF EGRESS SERVING 100 MAY BE PROVIDED
- WITH A LATCH OR LOCK ONLY IF IT IS PANIC HARDWARE.
- 16. 101:7.2.1.5.2. LOCKS ON DOOR IN ANY MEANS OF EGRESS SHALL NOT REQUIRE THE USE
 OF A KEY, SPECIAL DEVICE OR SPECIAL KNOWLEDGE TO OPEN IN THE DIRECTION OF EGRESS.
 17. EVERY BATHROOM DOOR SHALL BE DESIGNED TO ALLOW OPENING FROM THE OUTSIDE
- DURING AN EMERGENCY WHEN LOCKED.

 18. PROVIDE LANDINGS OUTSIDE EXTERIOR DOORS LEVEL WITH FLOOR.
- 19. CORRIDOR WIDTH SHALL NOT BE LESS THAN 44".20. 101:2.3.2. INTERIOR WALLS, CEILING AND FLOOR FINISHTO BE CLASS "A" FLAME SPREAD,
- 25' OR LESS.
 21. LAC 55;305. INSULATION AND INSULATION ASSEMBLIES SHALL MEET THE REQUIREMENTS OF INTERNATIONAL BUILDING CODE 2015, SEC. 719. CONCEALED AND EXPOSED INSULATION
- FIBER THERMAL INSULATION SHALL MEET THE REQUIREMENTS OF IBC 2015.

 22. LRS 40:1711. PROVIDE SAFETY GLAZING IN HAZARDOUS LOCATIONS AS PER SBC (1977)

SHALL HAVE A FLAME SPREAD OF 0-25 AND A SMOKE DEVELOPED OF 0-450. CELLULOSE

- 2405.2. INTERNATIONAL BUILDING CODE 2015 SEC. 2406.
 23. PRIOR TO CONSTRUCTION, THE CONTRACTOR SHALL VERIFY ALL UTILITIES.
- 24. BUILDING IS DESIGNED TO WITHSTAND 130 MPH AS PER IBC 2015.
- 25. SPECIAL NOTES PERTAINING TO THE BUILDING PERMIT.
- IN ORDER TO OBTAIN A PERMIT THESE PLANS MAY REQUIRE NECESSARY CORRECTIONS OR MODIFICATIONS FOR THE FOLLOWING REASONS.

 A. ADDITIONAL REQUIREMENTS BY THE CITY, PARISH (COUNTY), STATE AND FIRE MARSHAL.
- B. FEDERAL REQUIREMENTS.
 C. WHEN AN UNANTICIPATED SITE OR BUILDING CONDITIONS ARE ENCOUNTERED.

ORAFTING & DESIGN, LL 1987, Prairieville, La. 70769-1987

CREATIVE CRAFTS
7841 FLORIDA BLVD. EAST
ENHAM SPRINGS, LA 70726

JAMES A. WALSH, P.E. 10219 GLEN VIEW AVE. BATON ROUGE, LA. 70809

SCALE:

DRAWN BY:

CHARLES HARRIS


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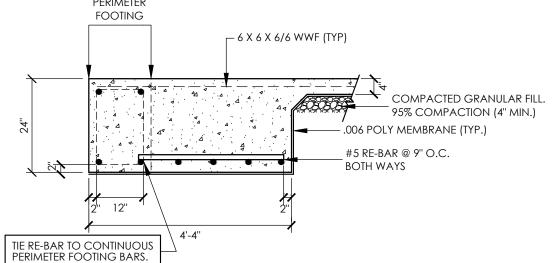


<u>A</u>-2


GENERAL NOTES: REINFORCING STEEL FOUNDATION WITHOUT PILES.

- 1. ENGINEER DID NOT INSPECT THIS SITE AND DOES NOT ATTEST TO ANY
- EXISTING UNUSUAL SITE OR SOIL CONDITIONS ON THE BUILDING SITE. 2. ENGINEER DOES NOT ATTEST THAT SETTLEMENT OF THE FOUNDATION WILL NOT OCCUR.
- 3. ENGINEER DOES NOT INSPECT THIS FOUNDATION FOR PLAN COMPLIANCE (UNLESS BY SEPARATE CONTRACT).
- 4. OWNER IS CAUTIONED TO EXERCISE POSITIVE DRAINAGE OF THE SITE BOTH FROM RAINFALL AND ANY INSTALLED SPRINKLER SYSTEMS AWAY FROM
- 5. REMOVE ALL SILTY SOILS, VEGETATION AND ORGANIC MATERIAL BELOW BOTTOM OF SLAB AND GRADE BEAMS. REPLACE WITH 95% COMPACTED NO-NORGANIC MATERIAL. THIS DESIGN ASSUMES AN EXISTING MINIMUM
- SOIL BEARING CAPACITY OF 2000 P.S.I. 6. LOT FILL BELOW THIS SLAB SHALL NOT EXCEED TWO FEET IN DEPTH UNLESS
- APPROVED BY ENGINEER. 7. ALL FILL AND FINAL GRADE SHALL EXTEND A MINIMUM OF FIVE FEET AROUND EXTERIOR GRADE BEAMS.
- 8. CONCRETE DESIGN IS BASED UPON A CONCRETE MIX HAVING A MAXIMUM OF 3.0 GALLONS OF FREE AND ADDED WATER PER CUBIC YARD. SUCH A MIX SHOULD GIVE A MINIMUM COMPRESSION STRENGTH OF 4000 P.S.I. AT 28 DAYS. CONCRETE DESIGN MIX SHALL BE IN ACCORDANCE WITH THE
- A.C.I. 318-77 AND LOCAL BUILDING CODE REQUIREMENT. 9. ALL CONVENTIONAL REINFORCING STEEL SHALL BE A.C.T. DESIGNATION A-615 (GRADE 60) REINFORCING AND SHALL BE DETAILED AND ACCESSORIES PROVIDED IN ACCORDANCE WITH THE LATEST A.C.I. MANUAL OF STANDARD
- PRACTICE FOR DETAILING REINFORCED CONCRETE STRUCTURES. 10. MESH AND BARS SHALL BE ADEQUATELY AND SECURELY SUPPORTED TO PREVENT VERTICAL AND HORIZONTAL MOVEMENT DURING PLACING OF
- 11. THE CONTRACTOR SHALL VERIFY ALL DROPS, OFFSETS, BRICK LEDGES AND BLOCK-OUTS ON ARCHITECTURAL PLANS AND NOTIFY THE ENGINEER OF ANY
- DISCREPANCIES THAT MAY EXIST. 12. REINFORCEMENT SHALL HAVE A MINIMUM OF 2" COVER IN GRADE BEAM BOTTOMS, 2" COVER IN BEAM SIDES AND TOPS, AND 1-1/2" COVER IN SLAB
- 13. PROVIDE .006 POLYETHYLENE MEMBRANE UNDER ALL CONCRETE SLAB AND GRADE BEAMS.
- 14. ALL SECTIONS SHOWN ARE AT MID-SPAN OF GRADE BEAMS UNLESS
- OTHERWISE SHOWN. 15. PIPES, CONDUITS, THIMBLES, ETC., TO PASS THROUGH CONCRETE SLAB OR
- BEAM MUST NOT CONFLICT WITH REINFORCING. 16. ANY DEVIATION FROM THIS PLAN OR SPECIFICATIONS WILL VOID THE
- ENGINEERS LIABILITY AND RESPONSIBILITY. 17. THIS DESIGN IS NOT INTENDED FOR FLOORS REQUIRING SPECIAL CONCRETE
- WEARING SURFACES OR IMPRINTS. 18. THIS DESIGN IS TO BE USED ONLY FOR THE BELOW LOCATION:



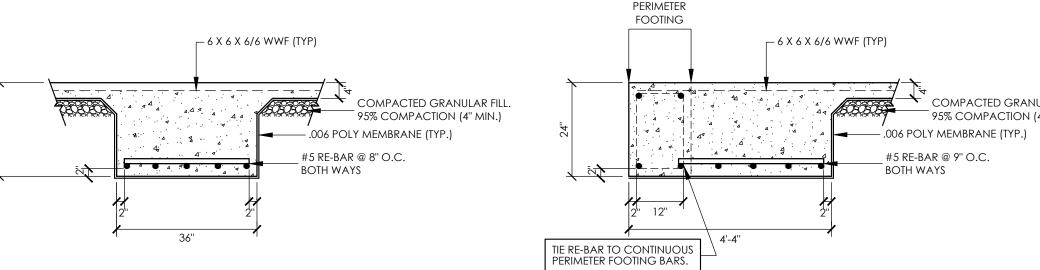


FOOTING 'A-A' FOOTING 'B-B'

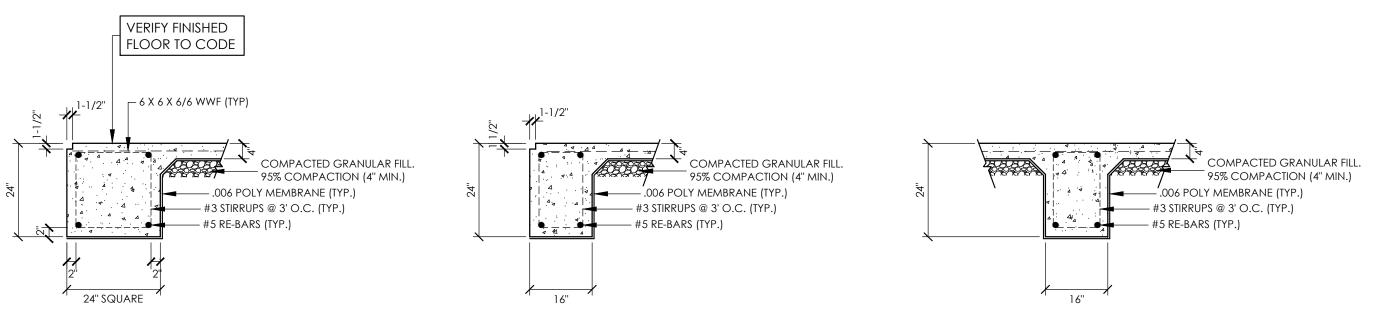

COLUMN FOOTING PERIMETER GRADE BEAM INTERIOR GRADE BEAM

> NOTE: ANY SITE FILL TO 95% COMPACTION

FOOTINGS SCALE: 1/2" = 1'-0"

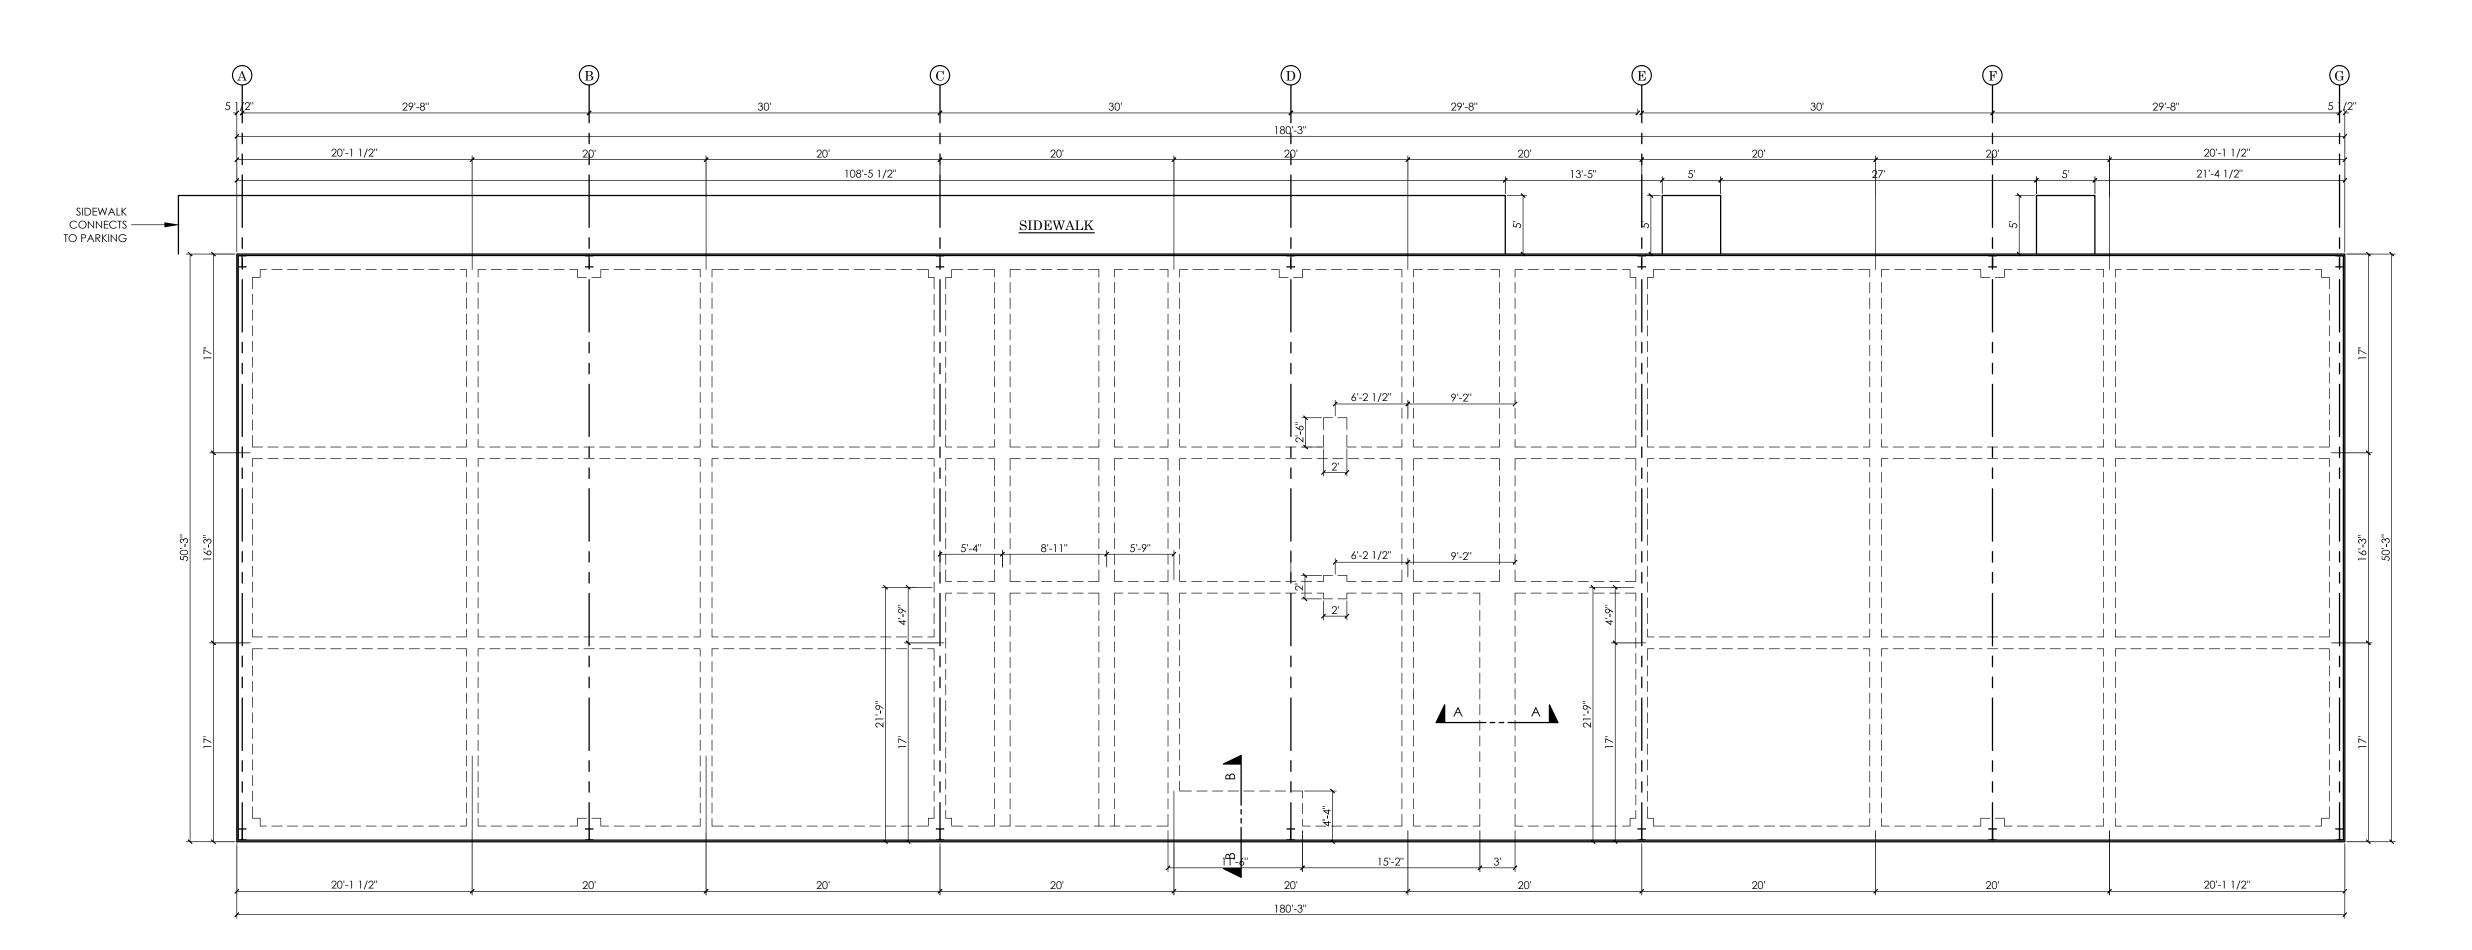

FOUNDATION PLAN SCALE: 1/8" = 1'-0"

ARRIS P.O.Bo»

CREATIVE CRAFT



PROFESSIONAL

	DOOR SCHEDULE FOR SUITES 'A', 'B' AND 'C'							
MARK	SIZE	DESCRIPTION	QTY.					
1	6-0 X 7-0 X 1-1/2 (PAIR)	METAL FRAME, FULL GLASS, DOUBLE GLASS, TEMPERED	2					
2	3-0 X 7-0 X 1-1/2	* METAL FRAME, FULL GLASS, DOUBLE GLASS, TEMPERED	3					
3	3-0 X 7-0 X 1-3/4	* METAL CLAD, STYRENE FILLED	5					
4	4-0 X 6-8 X 1-3/8	INTERIOR, SOLID CORE, 1 HOUR FIRE RATED, W/ AUTO CLOSURE	1					
5	3-0 X 6-8 X 1-3/8	* INTERIOR, SOLID CORE, WITH CLOSURE	3					
6	3-0 X 6-8 X 1-3/8	* INTERIOR, SOLID CORE	11					
7	6-0 X 6-8 X 1-3/8 (PAIR)	INTERIOR, SOLID CORE, WITH BALL CATCH	1					
8	4-8 X 6-8 X 1-3/8 (PAIR)	INTERIOR, SOLID CORE, WITH BALL CATCH	1					
9	14-0 X 14-0	* METAL OVERHEAD ROLL-UP	3					
10	4-0 X 6-8 X 1-3/8	INTERIOR SOLID CORE WITH CLOSURE	1					

-	10	4-U X 6-8 X 1-3/8	
	*INCLU	DES DOORS FROM SUITES 'D' & 'E'.	


	WINDOW SCHEDULE FOR SUITES 'A', 'B' AND 'C'								
MA	RK	SIZE	DESCRIPTION	QTY.					
*/	١	3-0 X 6-0	METAL FRAME, FIXED, DOUBLE GLASS	11					
E	3	4-0 X 6-0	METAL FRAME, FIXED, DOUBLE GLASS	3					

*INCLUDES WINDOWS FROM SUITES 'D' & 'E'.

SQUARE FOOTAGE SUITE 'A' SUITE 'B' 1816 SUITE 'C' 1696 5326 TOTAL






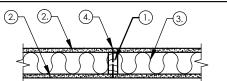


- 1. Framing Nominal 2 x 4 wood studs, spaced 16" o.c., single bottom plate.
- 2. Sheathing 5/8 in. Type X gypsum wallboard, 4 ft. wide, applied horizontally, unblocked. Horizontal application of wallboard represents the direction of least fire resistance as opposed to vertical application.
- 3. Insulation 3-1/2 in. thick mineral wool insulation (2.5 pcf, nominal) 4. Fasteners - 2-1/4 in. Type S drywall screws, spaced 12 in. o.c.
- 5. Joints and Fastener Heads Wallboard joints covered with paper tape and joint compound, fastener heads covered with joint compound.
- Tests conducted at the Fire Test Laboratory of National Gypsum Research Center. Test No: WP-1248 (Fire Endurance) March 29, 2000. WP-1246 (Hose Stream) March 9, 2000.

Third Party Witness: Intertek Testing Services. Report J20-06170.1



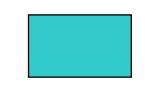


1 HOUR FIRE RATED CONSTRUCTION

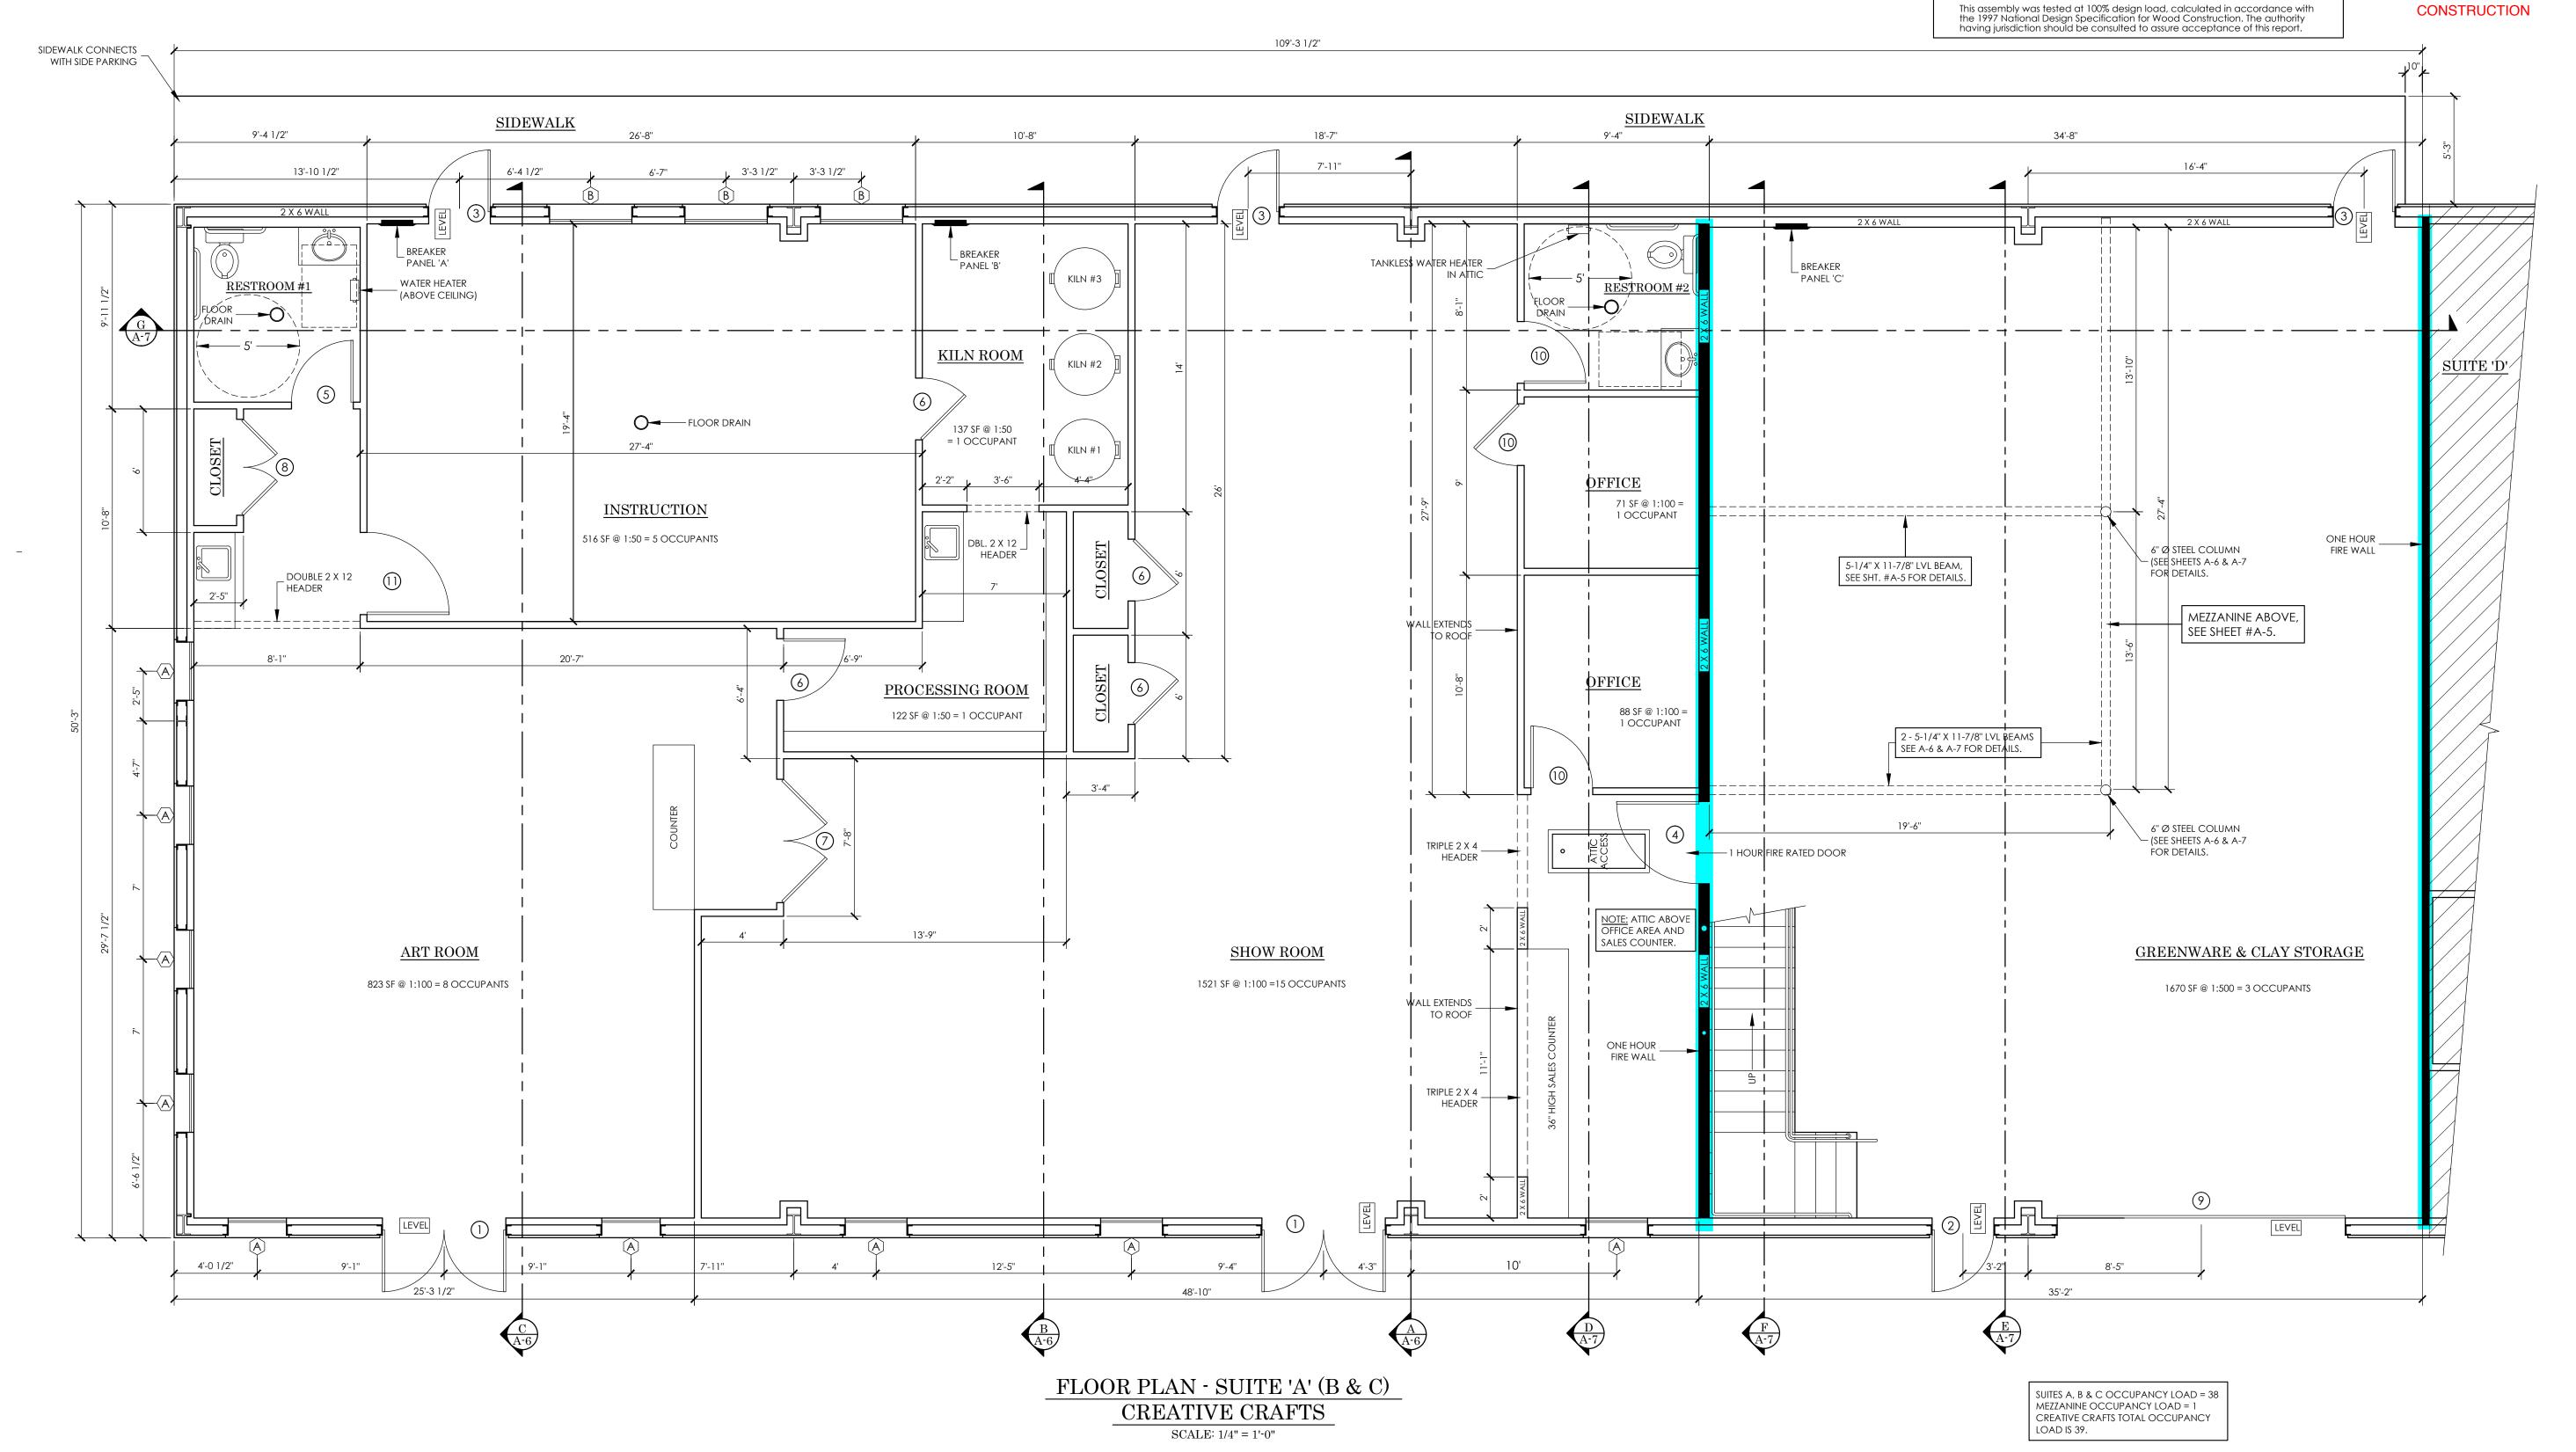




CREATIVE CRAFTS

SHEET NO.

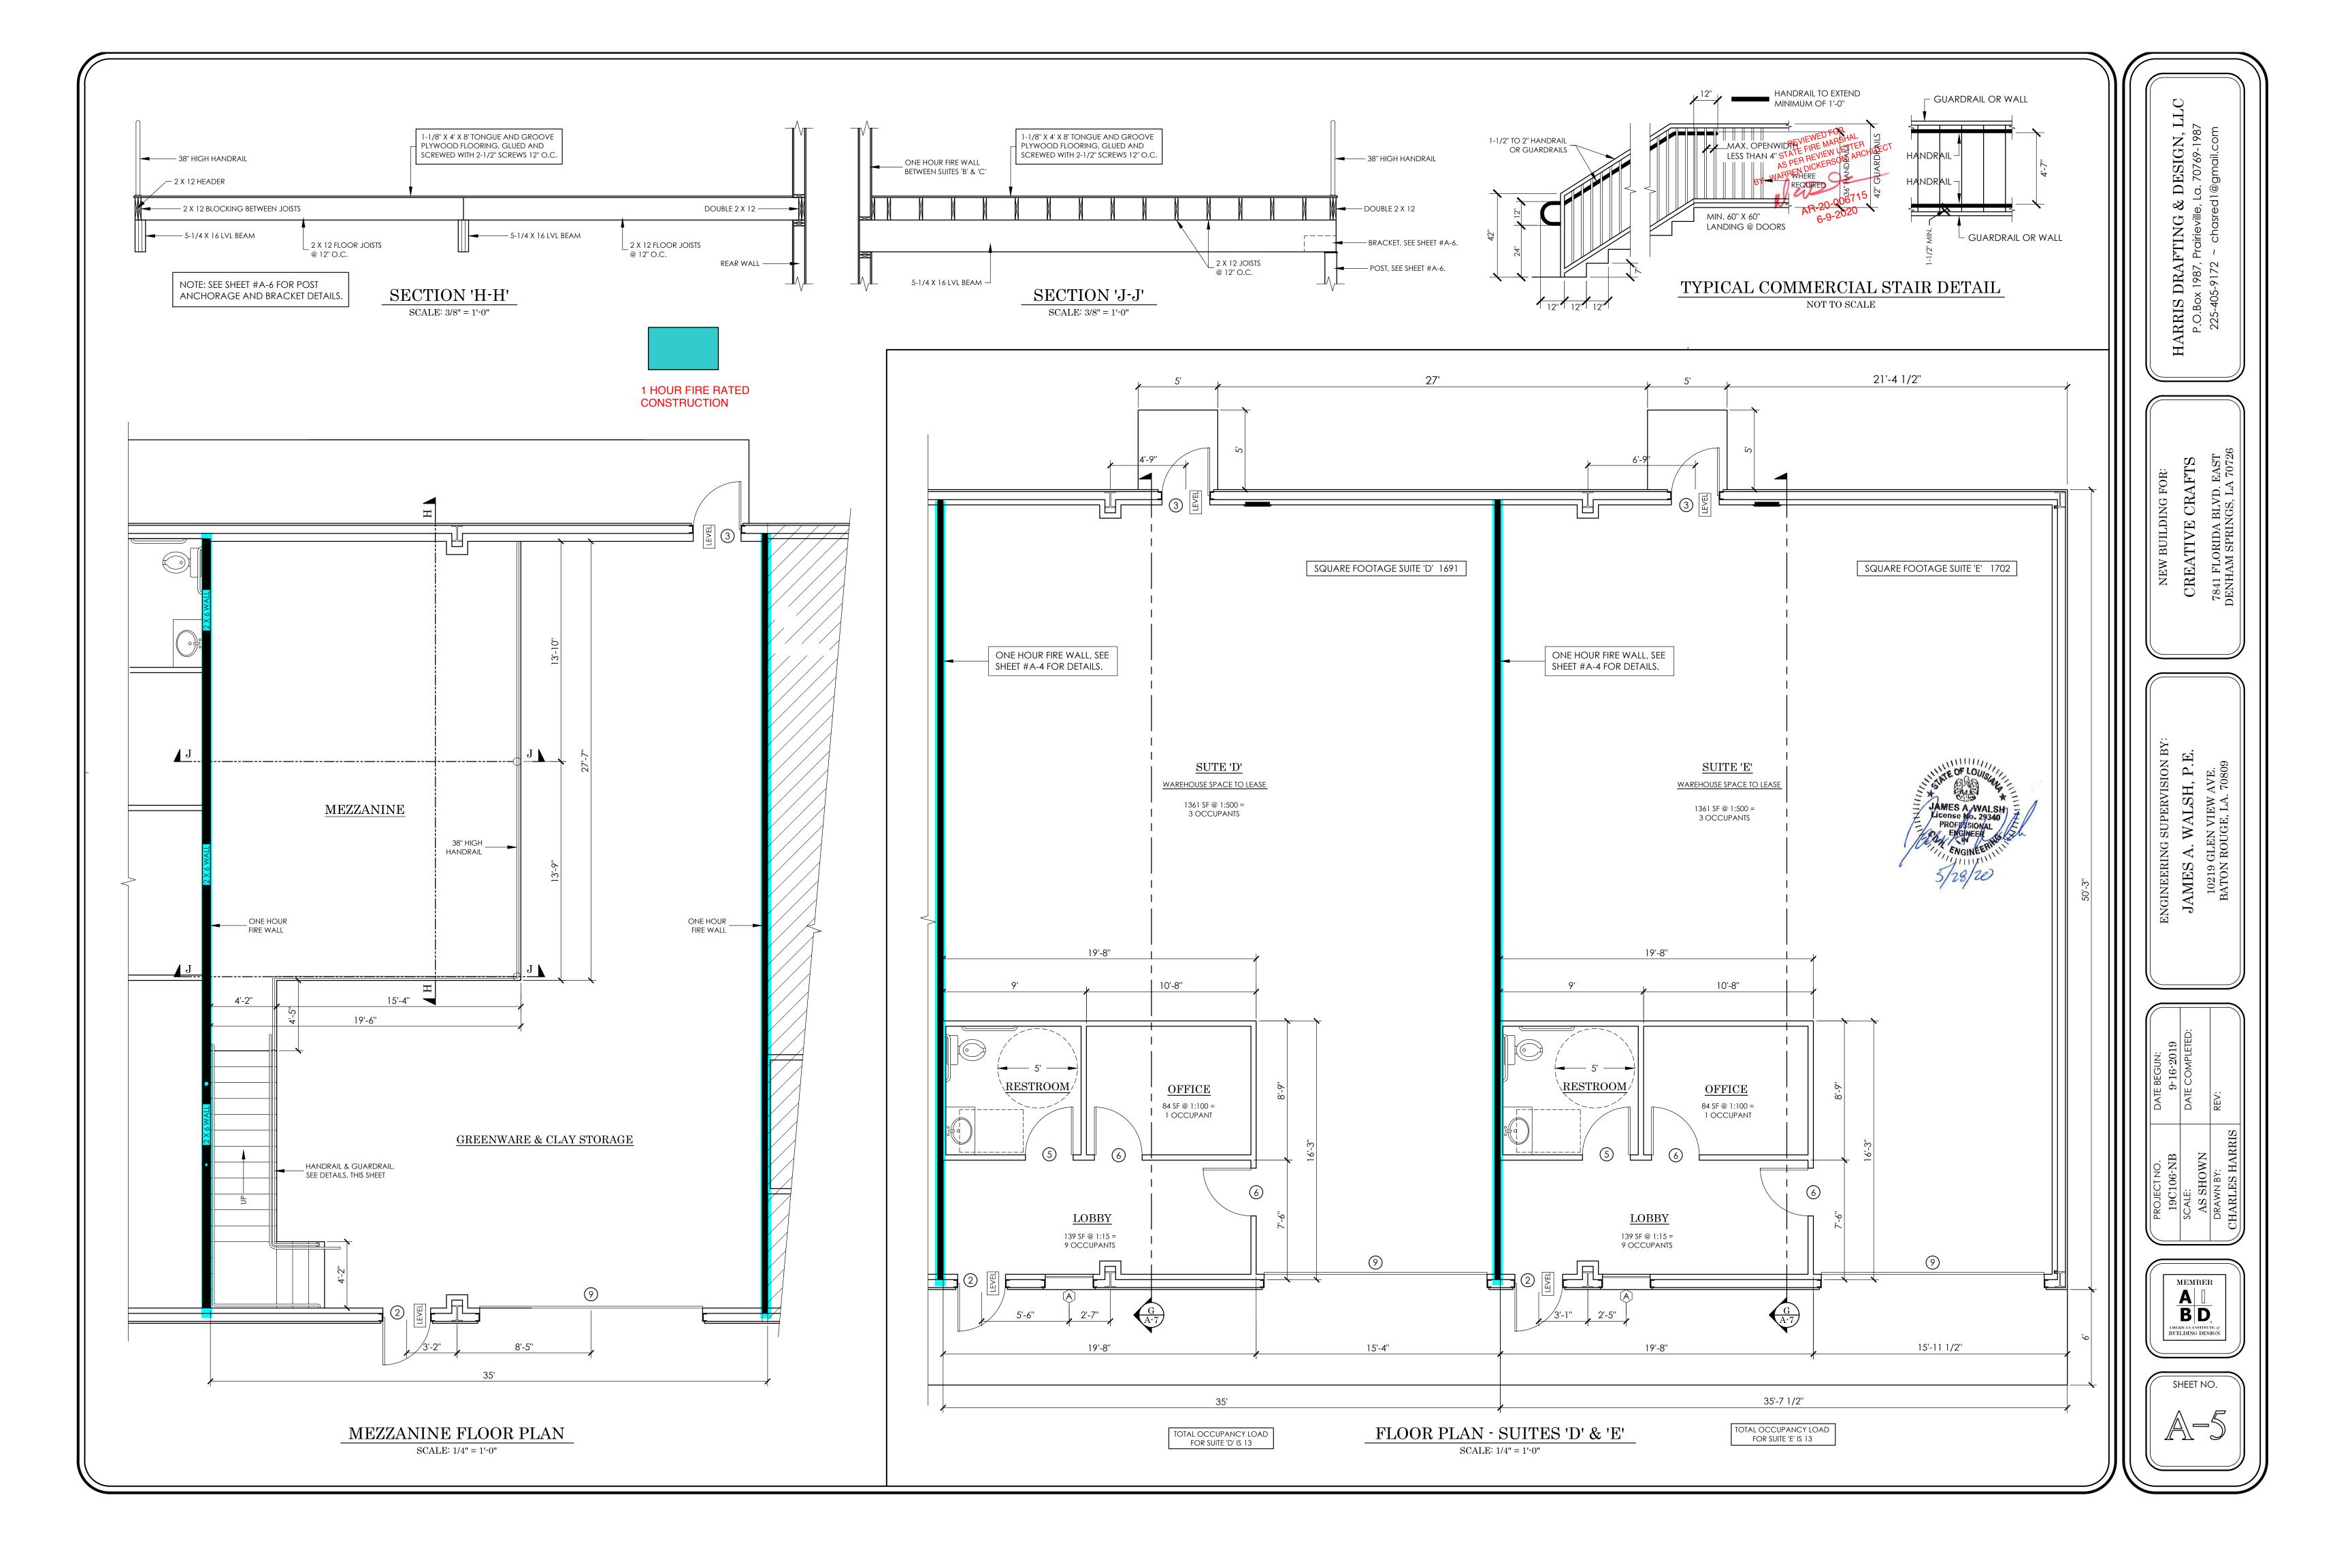

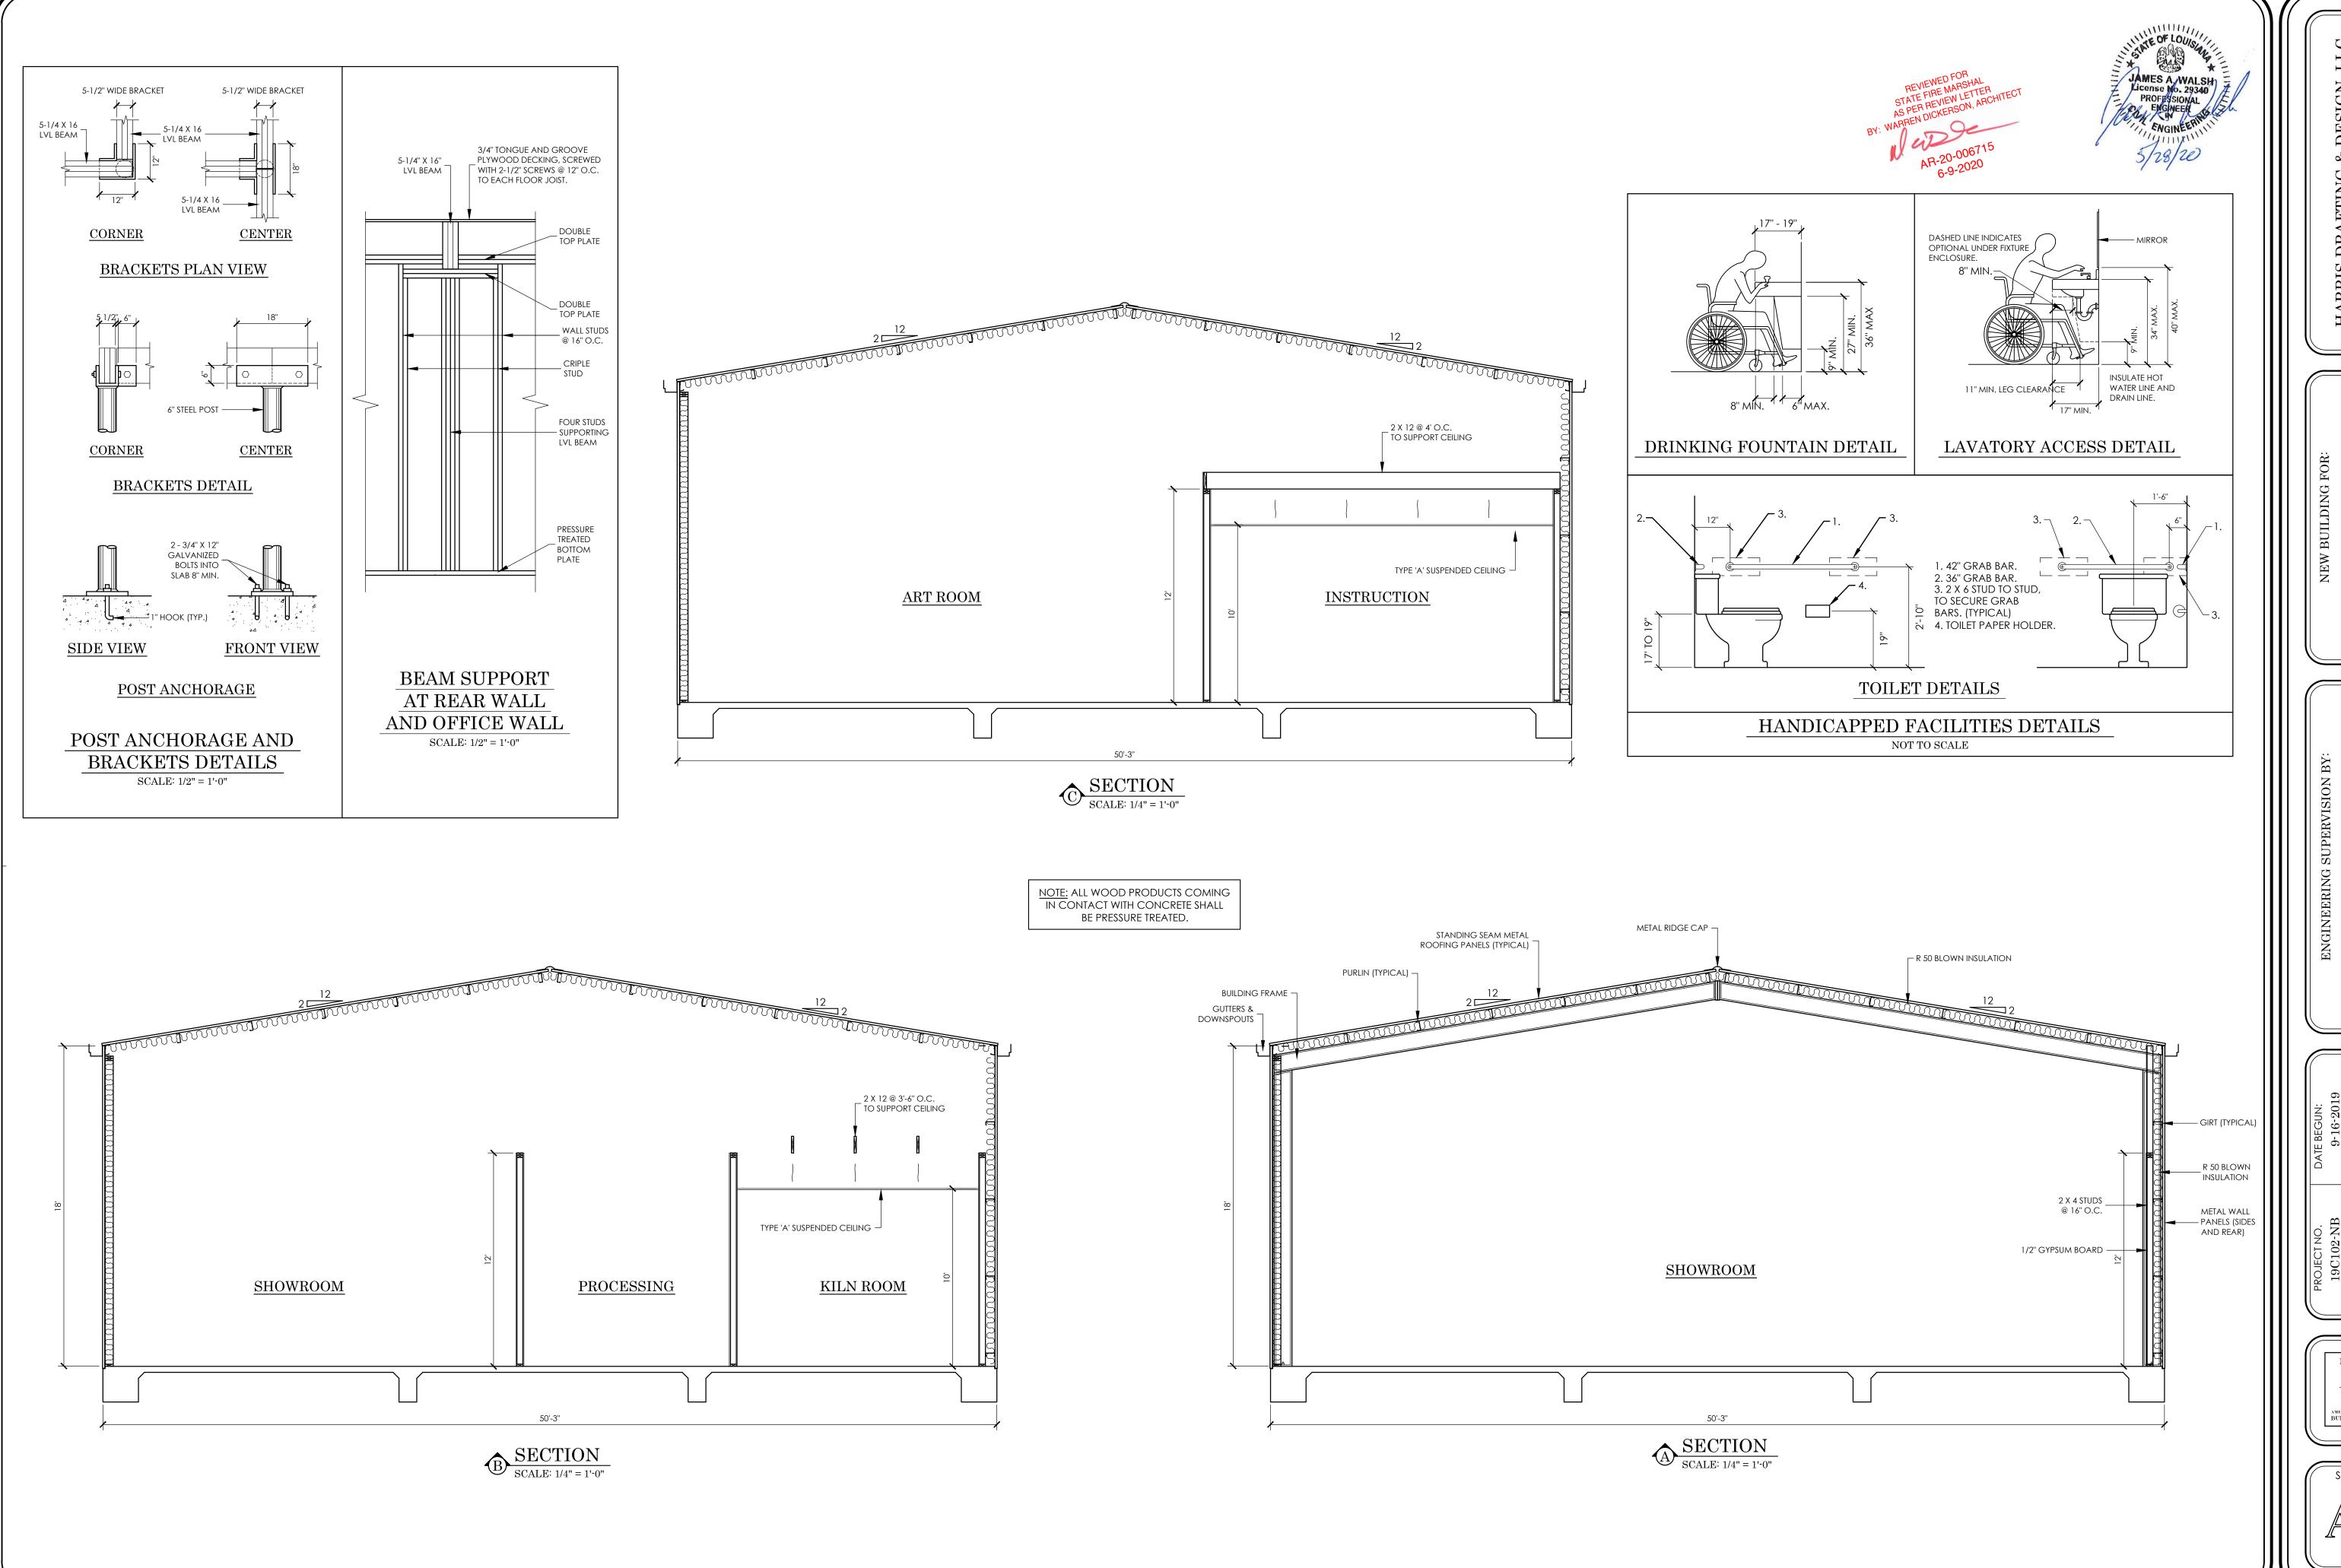



IGINEERING SUPERVISION BY:
JAMES A. WALSH, P.E.
10219 GLEN VIEW AVE.
BATON ROUGE, LA. 70809

DATE BEGUN:
9-16-2019
DATE COMPLETED:
REV:
BAY

	j	
	CHARLES HARRIS	
REV:	DRAWN BY:	
	AS SHOWN	
DATE COMPL	SCALE:	
9 - 16 - 20	19C102-NB	
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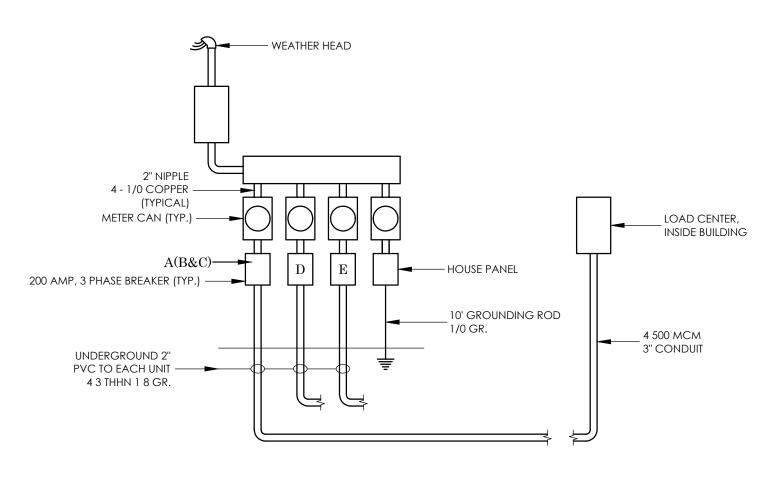
ARRIS P.O.Box

NEW BUILDING FOR: CREATIVE CRAFTS

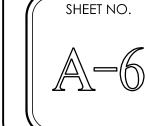PANEL "D" RISER NOT TO SCALE

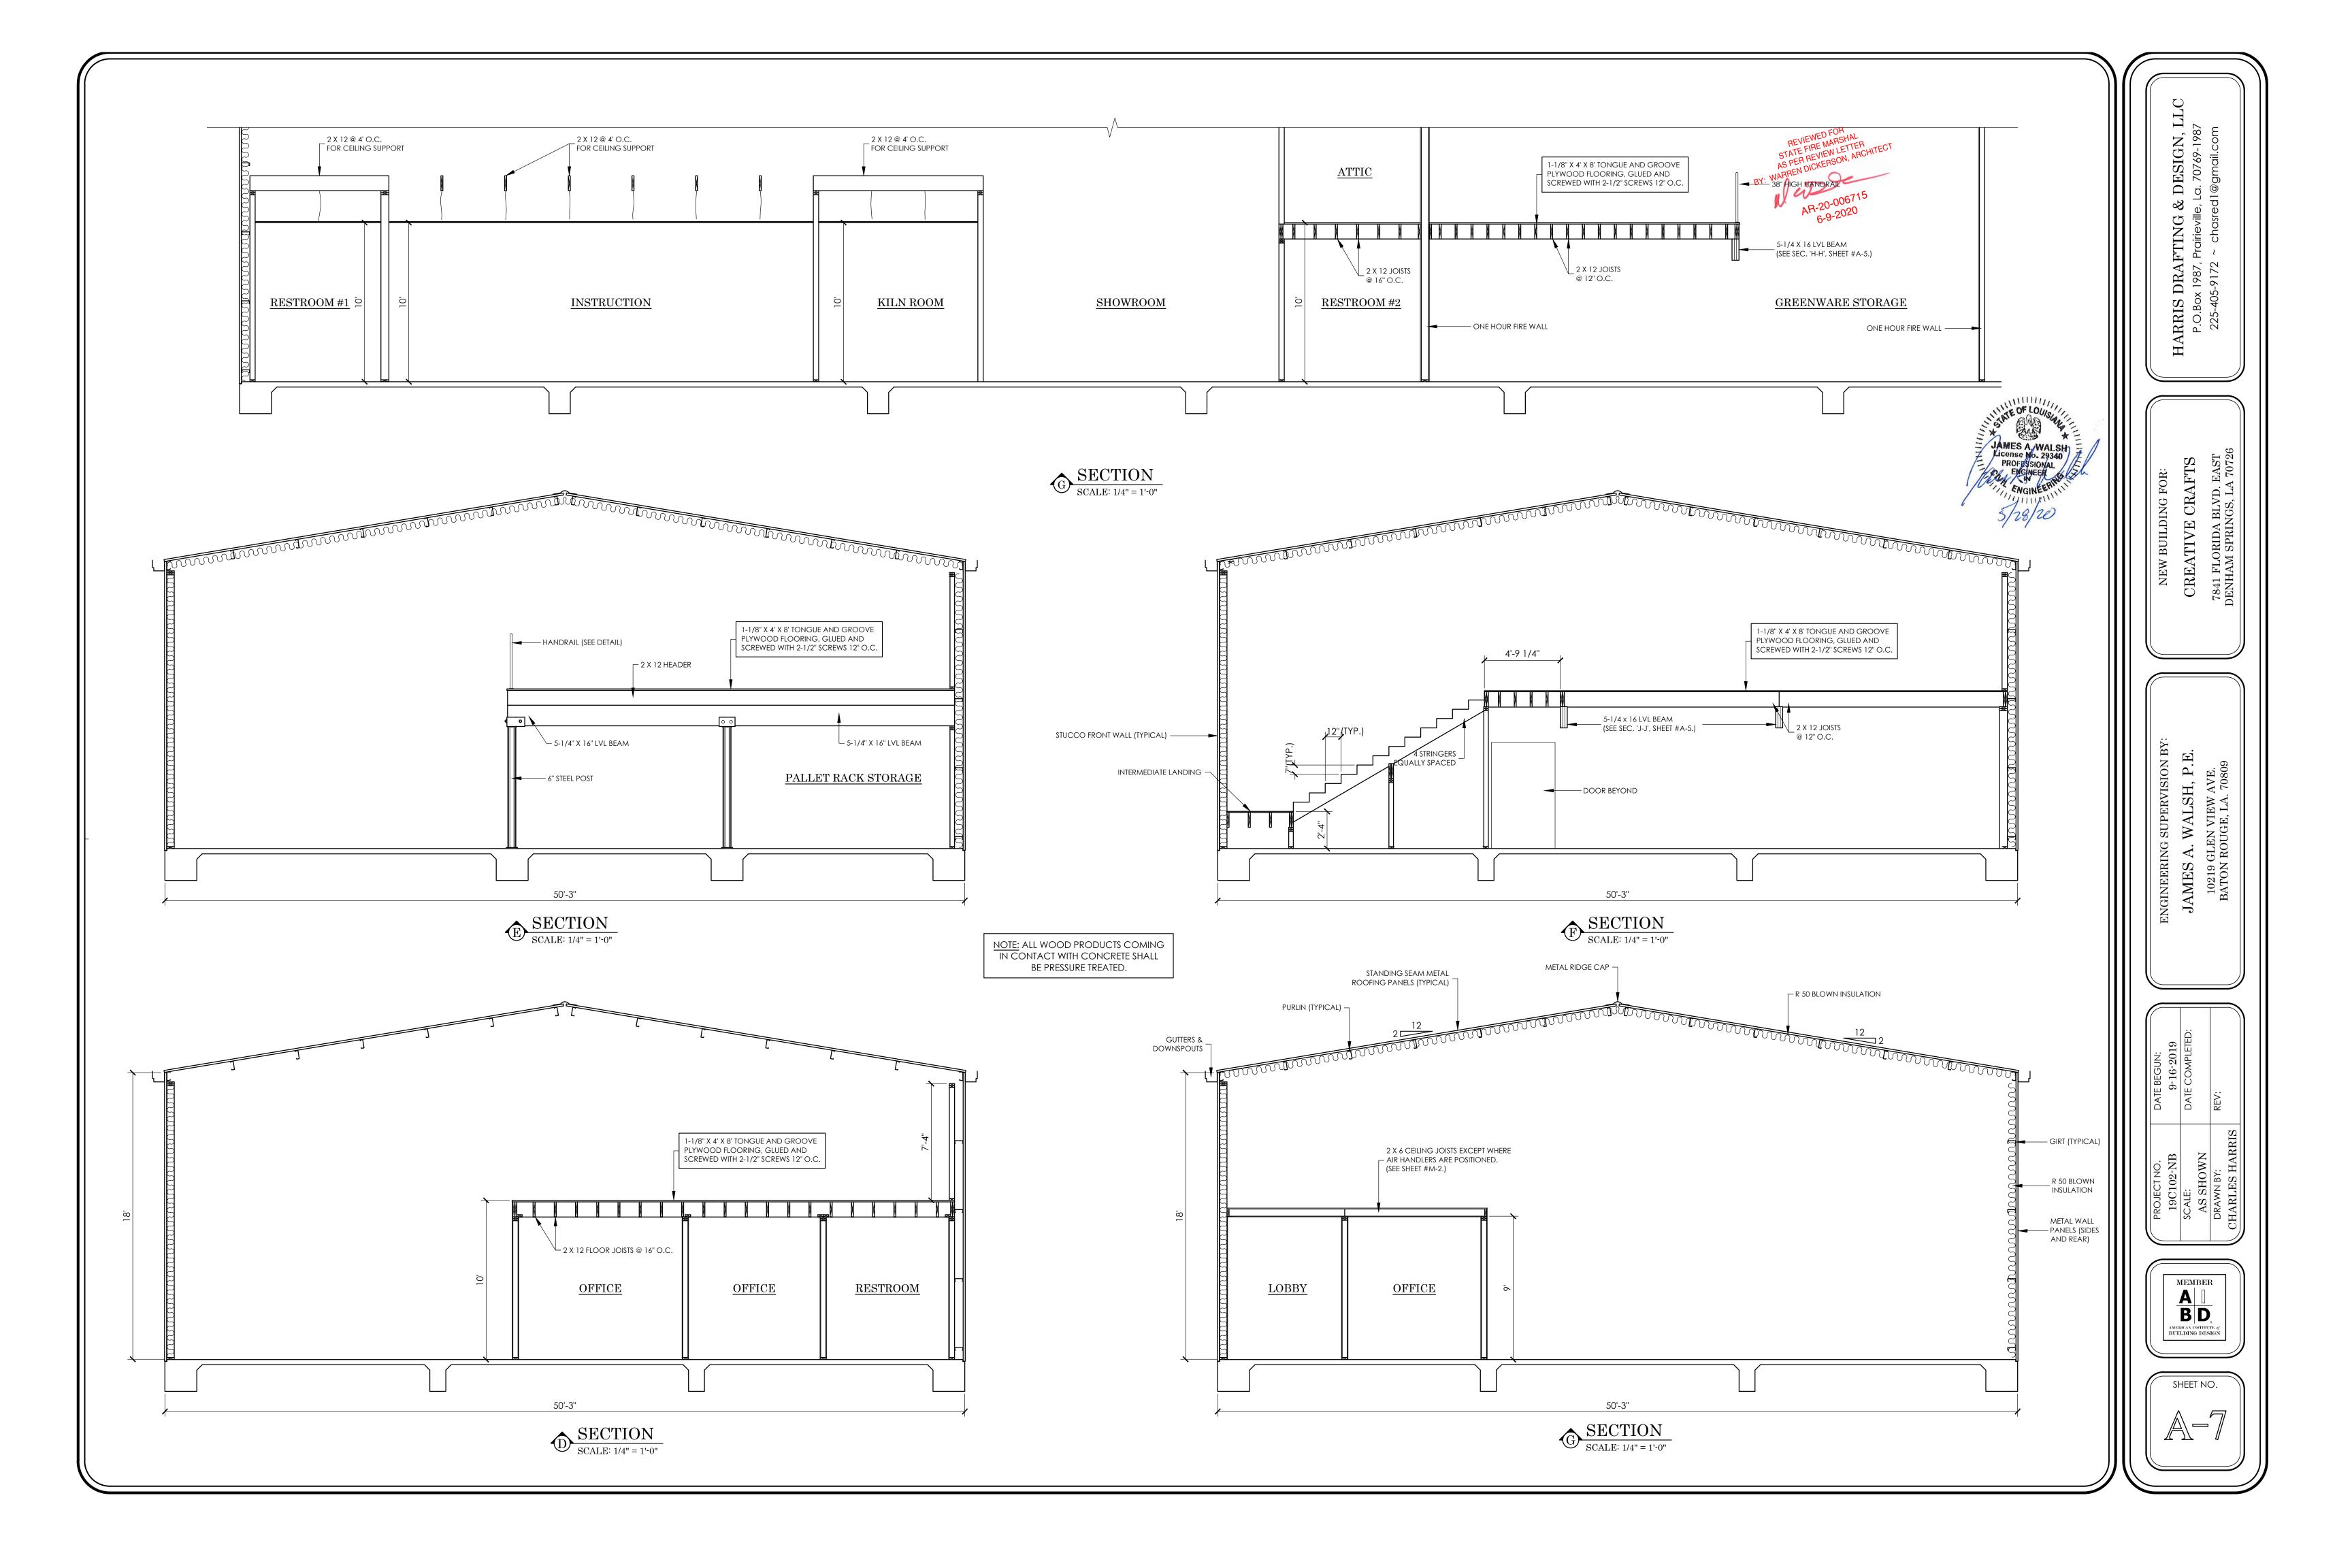PANEL "E" 200 AMP BREAKER, 120/208V, 3 Ø POWER DESCRIPTION CIR. AMP & S & AMP CIR. POWER DESCRIPTION 20 6 RECEPTACLES 20 8 RECEPTACLES SPARE 20 | 10 | RECEPTACLES 12 SPARE TO NEUTRAL BUS -TO GROUND BUS TO PANEL "A"

> PANEL "E" RISER NOT TO SCALE



ELECTRICAL RISER DIAGRAM WITH GROUNDING NOT TO SCALE

		200 A	P, MP BR	ANE Eake	EL '', R, 120	4'')/208\	′,3 Ø		
POWER DESCRIPTION	WER DESCRIPTION CIR. NO. AMP & S & W AMP CIR. NO. POWE								POWER DESCRIPTION
	1		—	-				2	
A/C	3			—	_			4	COND.
	5				H	-		6	
WATER HEATER	7	30		-			20	8	LIGHTS
WATER HEATER	9	30		_	-		20	10	RECEPTACLES
LIGHTS	11	20			H	-	20	12	RECEPTACLES
LIGHTS	13	20	H	-			20	14	RECEPTACLES
LIGHTS	15	20		—	-		20	16	RECEPTACLES
TO PANEL "B"	17	200			H	-	_	18	SPARE
TO PAINEL B	19	200	H	-			-	20	SPARE
TO PANEL 'C'	21	200		_	-		-	22	SPARE
TO PANEL C	23	200			H	-	-	24	SPARE
TO NEI	JTRAL TO ME			ا ل	ا را 		- TO	GROU	IND BUS

PANEL "A" RISER NOT TO SCALE

		200 A	PA MP BREA	NEL KER,	. ''B'' 120/208'	/,3 Ø		
POWER DESCRIPTION	CIR. NO.	AMP	∀ Ø	ØB	ØC	AMP	CIR. NO.	POWER DESCRIPTION
	1		+	-			2	
A/C	3			+		1	4	COND.
	5				+	1	6	
WATER HEATER	7	30	+	+		20	8	LIGHTS
WAIER HEATER	9	30		+		20	10	LIGHTS
KILN #1	11	40			+	20	12	RECEPTACLES
KILIN # I	13	40	 	+		20	14	RECEPTACLES
VII.N. #0	15	40		+		20	16	RECEPTACLES
KILN #2	17			-	+	20	18	RECEPTACLES
KILN #3	19	40	 	-		20	20	KILN EXHAUST FANS
KILIN #3	21	40		+		_	22	SPARE
SPARE	23	-			+	-	24	SPARE
TO NEI	JTRAL PANE					- TO	GROU	IND BUS

PANEL "B" RISER NOT TO SCALE

PANEL "C" 200 AMP BREAKER, 120/208V, 3 POWER DESCRIPTION CIR. AMP & & Q AMP CIR. POWER DESCRIPTION TO PANEL "A"

> PANEL"C" RISER NOT TO SCALE

4 SPARE

20 8 RECEPTACLES

16 SPARE 18 SPARE

▼−TO GROUND BUS

ALL ELECTRICAL WIRING

- 1. Electrical shall comply with NFPA 70, National Electrical Code for State of Louisiana, and the International Building Code 2015. For New Orleans Projects to conform to the New Orleans Amendments to the IBC articles 101.4.1., 106.1, 2701.
- 2. Electrical installations in hollow spaces, verticle shafts, and ventilation or air handling ducts shall be so made that possible spread of fire or products of combustion will not be substantially increased. Openings around electrical penetrations through fire rated walls, partitions, floors, or ceilings shall be fire stopped using approved methods to maintain the fire resistance rating in accordance with NFPA 70:300-21.
- 3. Provide service equipment, panels, circuit breakers and fuses with adequate interrupting amp capacity rating in accordance with NFPA
- 4. Working minimum clearance space in front of electrical switches, circuit breakers, panel boards, switch boards, etc., shall comply with NFPA
- 5. Receptacles in bathrooms of commercial, industrial and all other nondwelling occupancies shall provide ground-fault circuit-interrupter protection for personnel in accordance with NFPA 70:210 8b(1).
- 6. Service equipment grounding and bonding is to be in accordance with NFPA 70:230-63; 250-23; 250-71 and 250-72. 7. The grounded neutral conductor shall be run to each service disconnecting
- means and shall be bonded to each in accordance with NFPA 70:250-23b.
- 8. Provide electrical equipment ground conductor in accordance with NFPA 70:250-91b and NFPA 70:250-95.
- 9. No conductor shall be used in such a manner that its operating temperature will exceed the designation for the type of insulated conductor involved
- in accordance with NFPA 70:310-10. Interior metal water piping systems and exposed structural steel that is likely to become energized shall be bonded to the service equipment
- enclosure in accordance with NFPA 250-80.
- 11. All electrical outlets located within six feet of any water holding containers must have ground fault circuit interrupter protection.
- 12. For buildings having an occupancy of 50 or more all electrical wiring shall be in raceways.


ELECTRIC	CAL FIXTURE SCHEDULE
/A//	24" X 48" LED LAY-IN FIXTURE BY LITHONIA
B	24" X 24" LED LAY-IN FIXTURE BY LITHONIA
<u>©</u>	DOWNLIGHT RECESSED FIXTURE BY LITHONIA MODEL WF8, 27K30K35K, 1800 LUMENS
D	DOWNLIGHT RECESSED FIXTURE BY LITHONIA MODEL LDN6, 13W, 1000 LUMENS, INCLUDES HOUSING
F	LED UFO HIGH-BAY 150 OR 200W, 19,500/26,000 LUMENS OR HIGH-BAY ALUM. LENS 150W, 1700 LUMENS (PHILLIPS)
EXIT	EXIT SIGN WITH BATTERY BACK-UP LITHONIA MODEL NO. LQMSW3R-120/277-ELN
R	FAHRENHEIT 6" WHITE RING LED RECESSED LIGHT MODEL #LED61051-SA-FR (OR EQUIVALENT)
7.0	DUAL HEAD LIGHT, EMERGENCY WALL LIGHT LITHONIA MODEL NO. ELM
4⊗∆	SUPERIOR LIGHTING DUSK TO DAWN LED SECURITY LIGHT MOD. #7101CAAL045, 45 WATT, 4,900 LUMENS (OR EQUIV
\$	SWITCH
#	RECEPTACLE
#	220 RECEPTACLE
Y	TELEPHONE JACK
@	#1544 KILN VENT, 120V, 15A.
@	BROAN MODEL A110, 120V, 4" DUCT, CEILING MOUNT EXHAUST FAN.
	RHEEM RTEX-18 TANKESS WATER HEATER (OR EQUIV.)


CAT 5 FOR COMPUTERS



1. KILNS ARE: KILNS ARE: KM1227-3" KILNMASTER BY SKUTT. 3 PHASE, 208 VOLTS, 31.7 AMPS, 11000 WATTS. REQUIRES 40 AMP BREAKER. 2. WATER HEATERS ARE: AMTOR 3KW, 110V, SUPREME SERIES ELECTRIC,

TANKLESS, INSTANT WATER HEATER. REQUIRES 10 AWG WIRE, 110 CONNECTION, AND 30 AMP DEDICATED BREAKER. 3. KILN VENT HOODS ARE MODEL #1544 BY SKUTT, 110 VOLTS, 15 AMP.

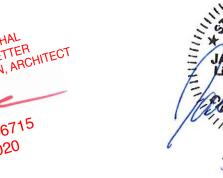

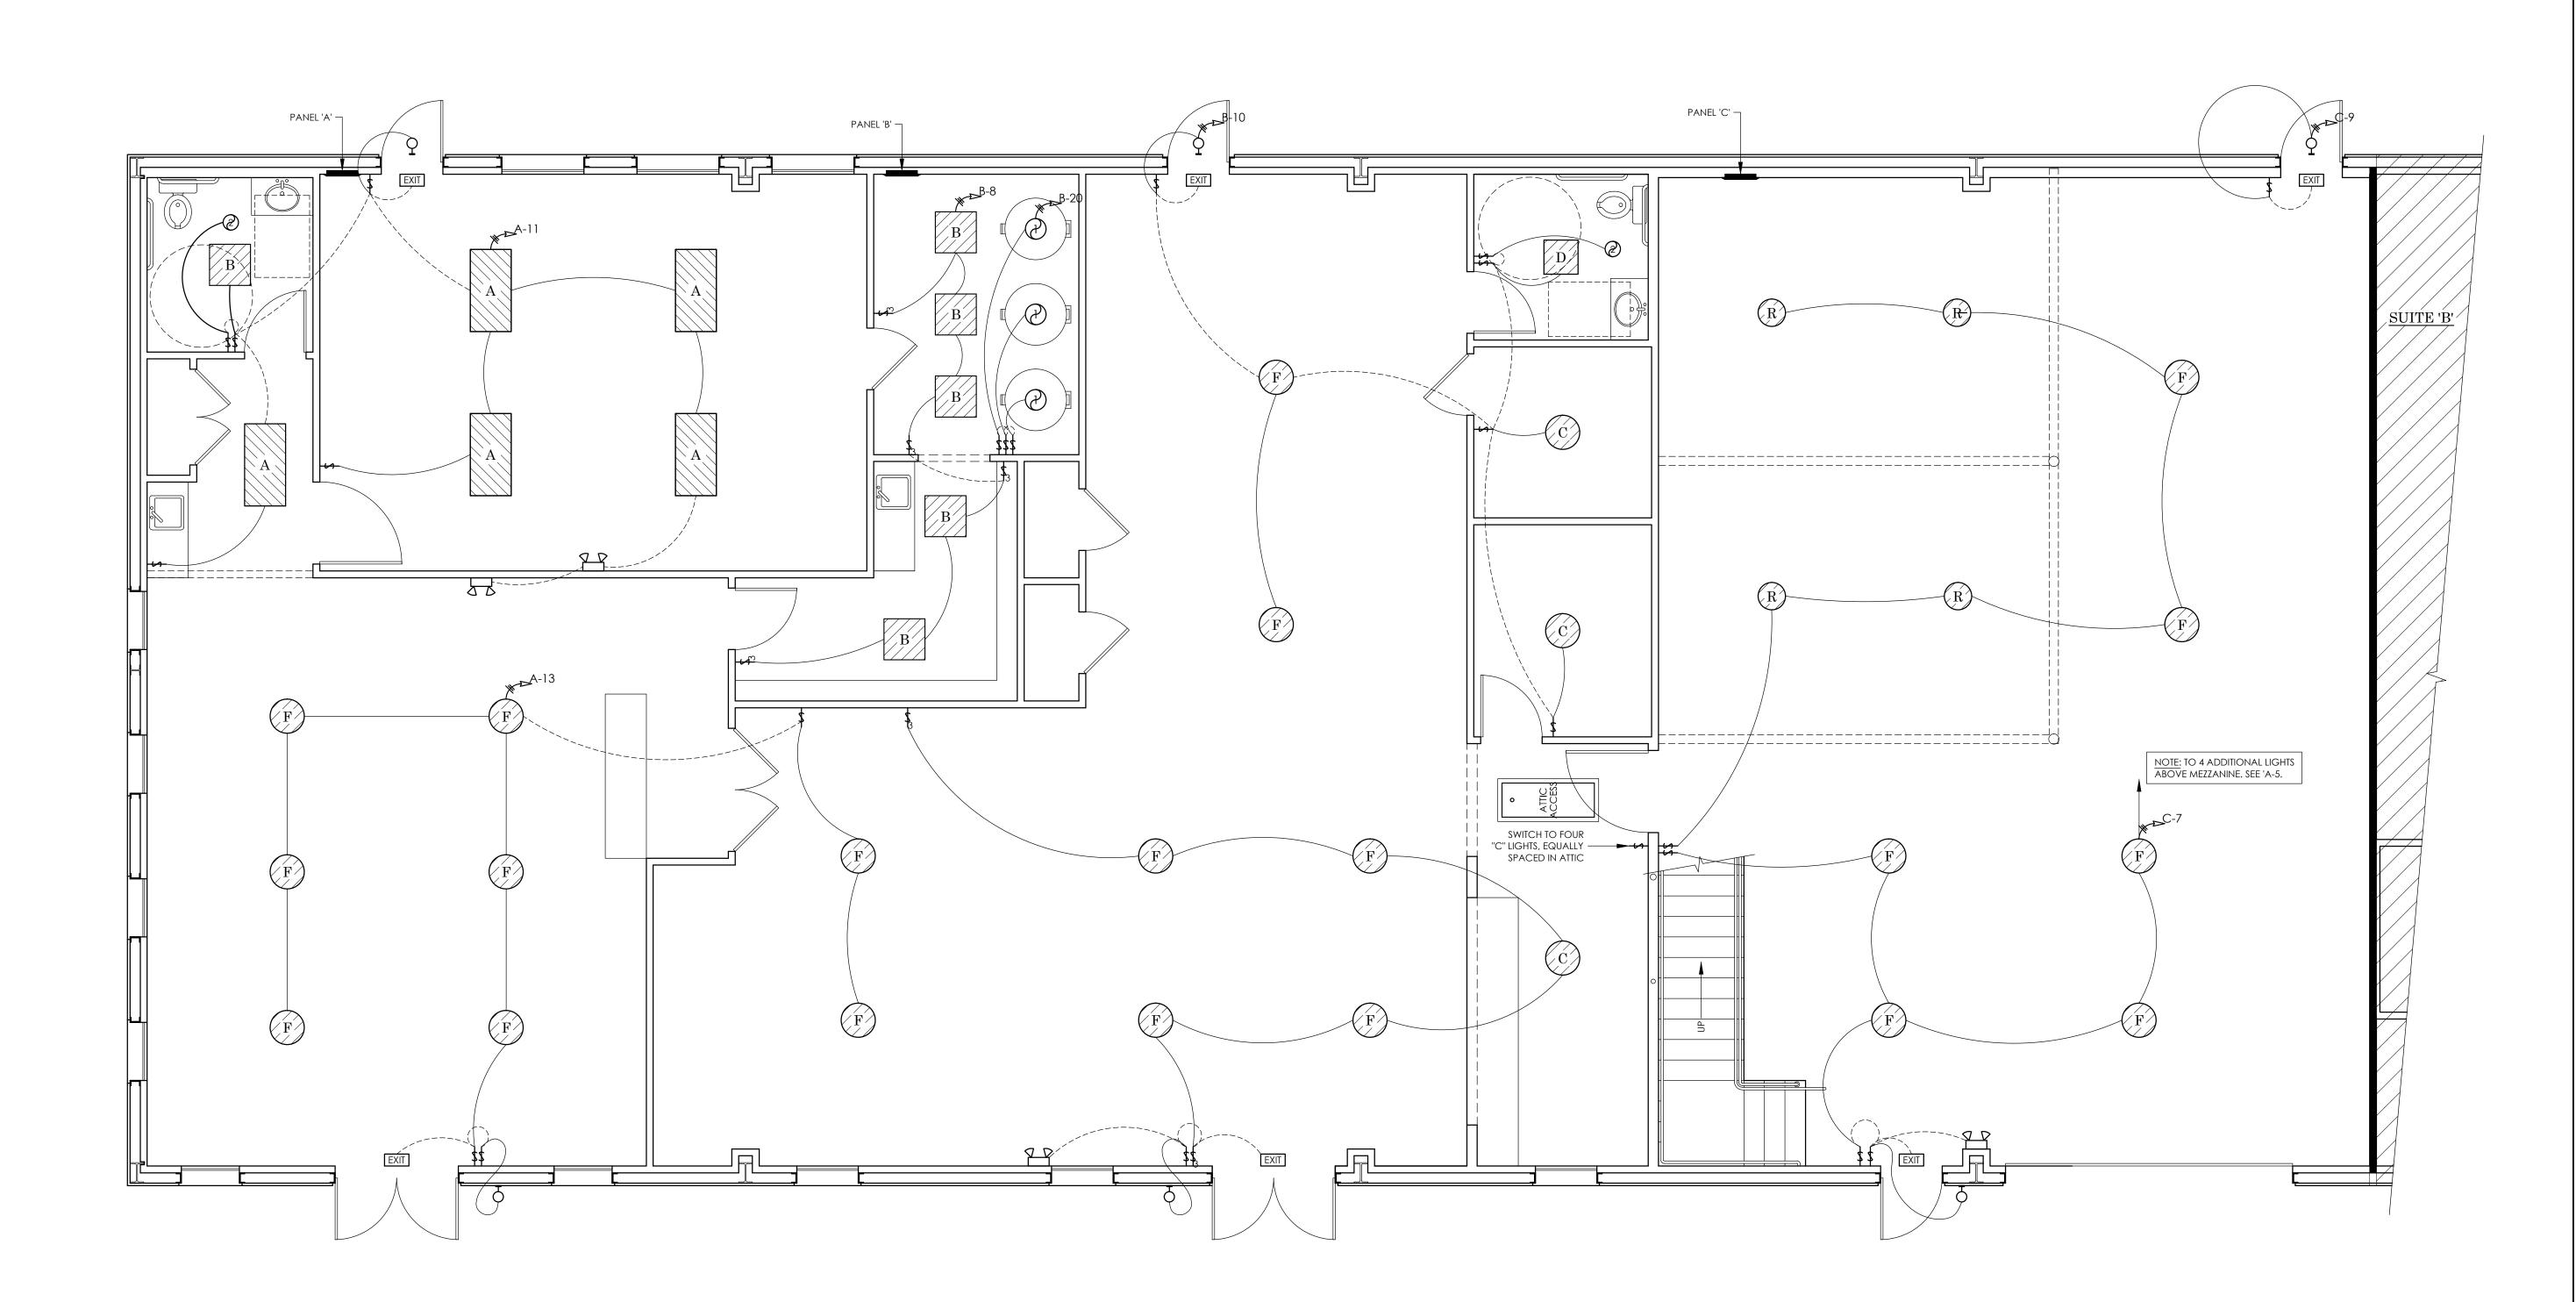

LIGHTING PLAN - SUITE 'A' (B & C)

SCALE: 1/4" = 1'-0"

NEW BUILDING FOR:

CREATIVE CRAFTS
7841 FLORIDA BLVD. EAST
DENHAM SPRINGS, LA 70726

ENGINEERING SUPERVISION BY:

JAMES A. WALSH, P.E.

10219 GLEN VIEW AVE.


BATON ROUGE, LA. 70809

SCALE:
AS SHOWN
DRAWN BY:
CHARLES HARRIS

19C106-NB
DATE COMPLETEI
REV:
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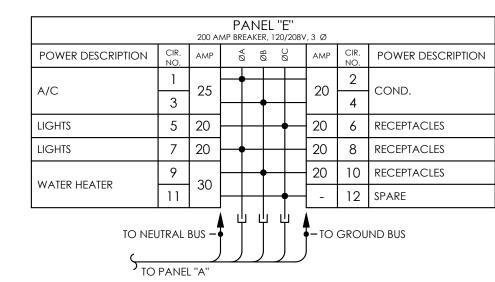




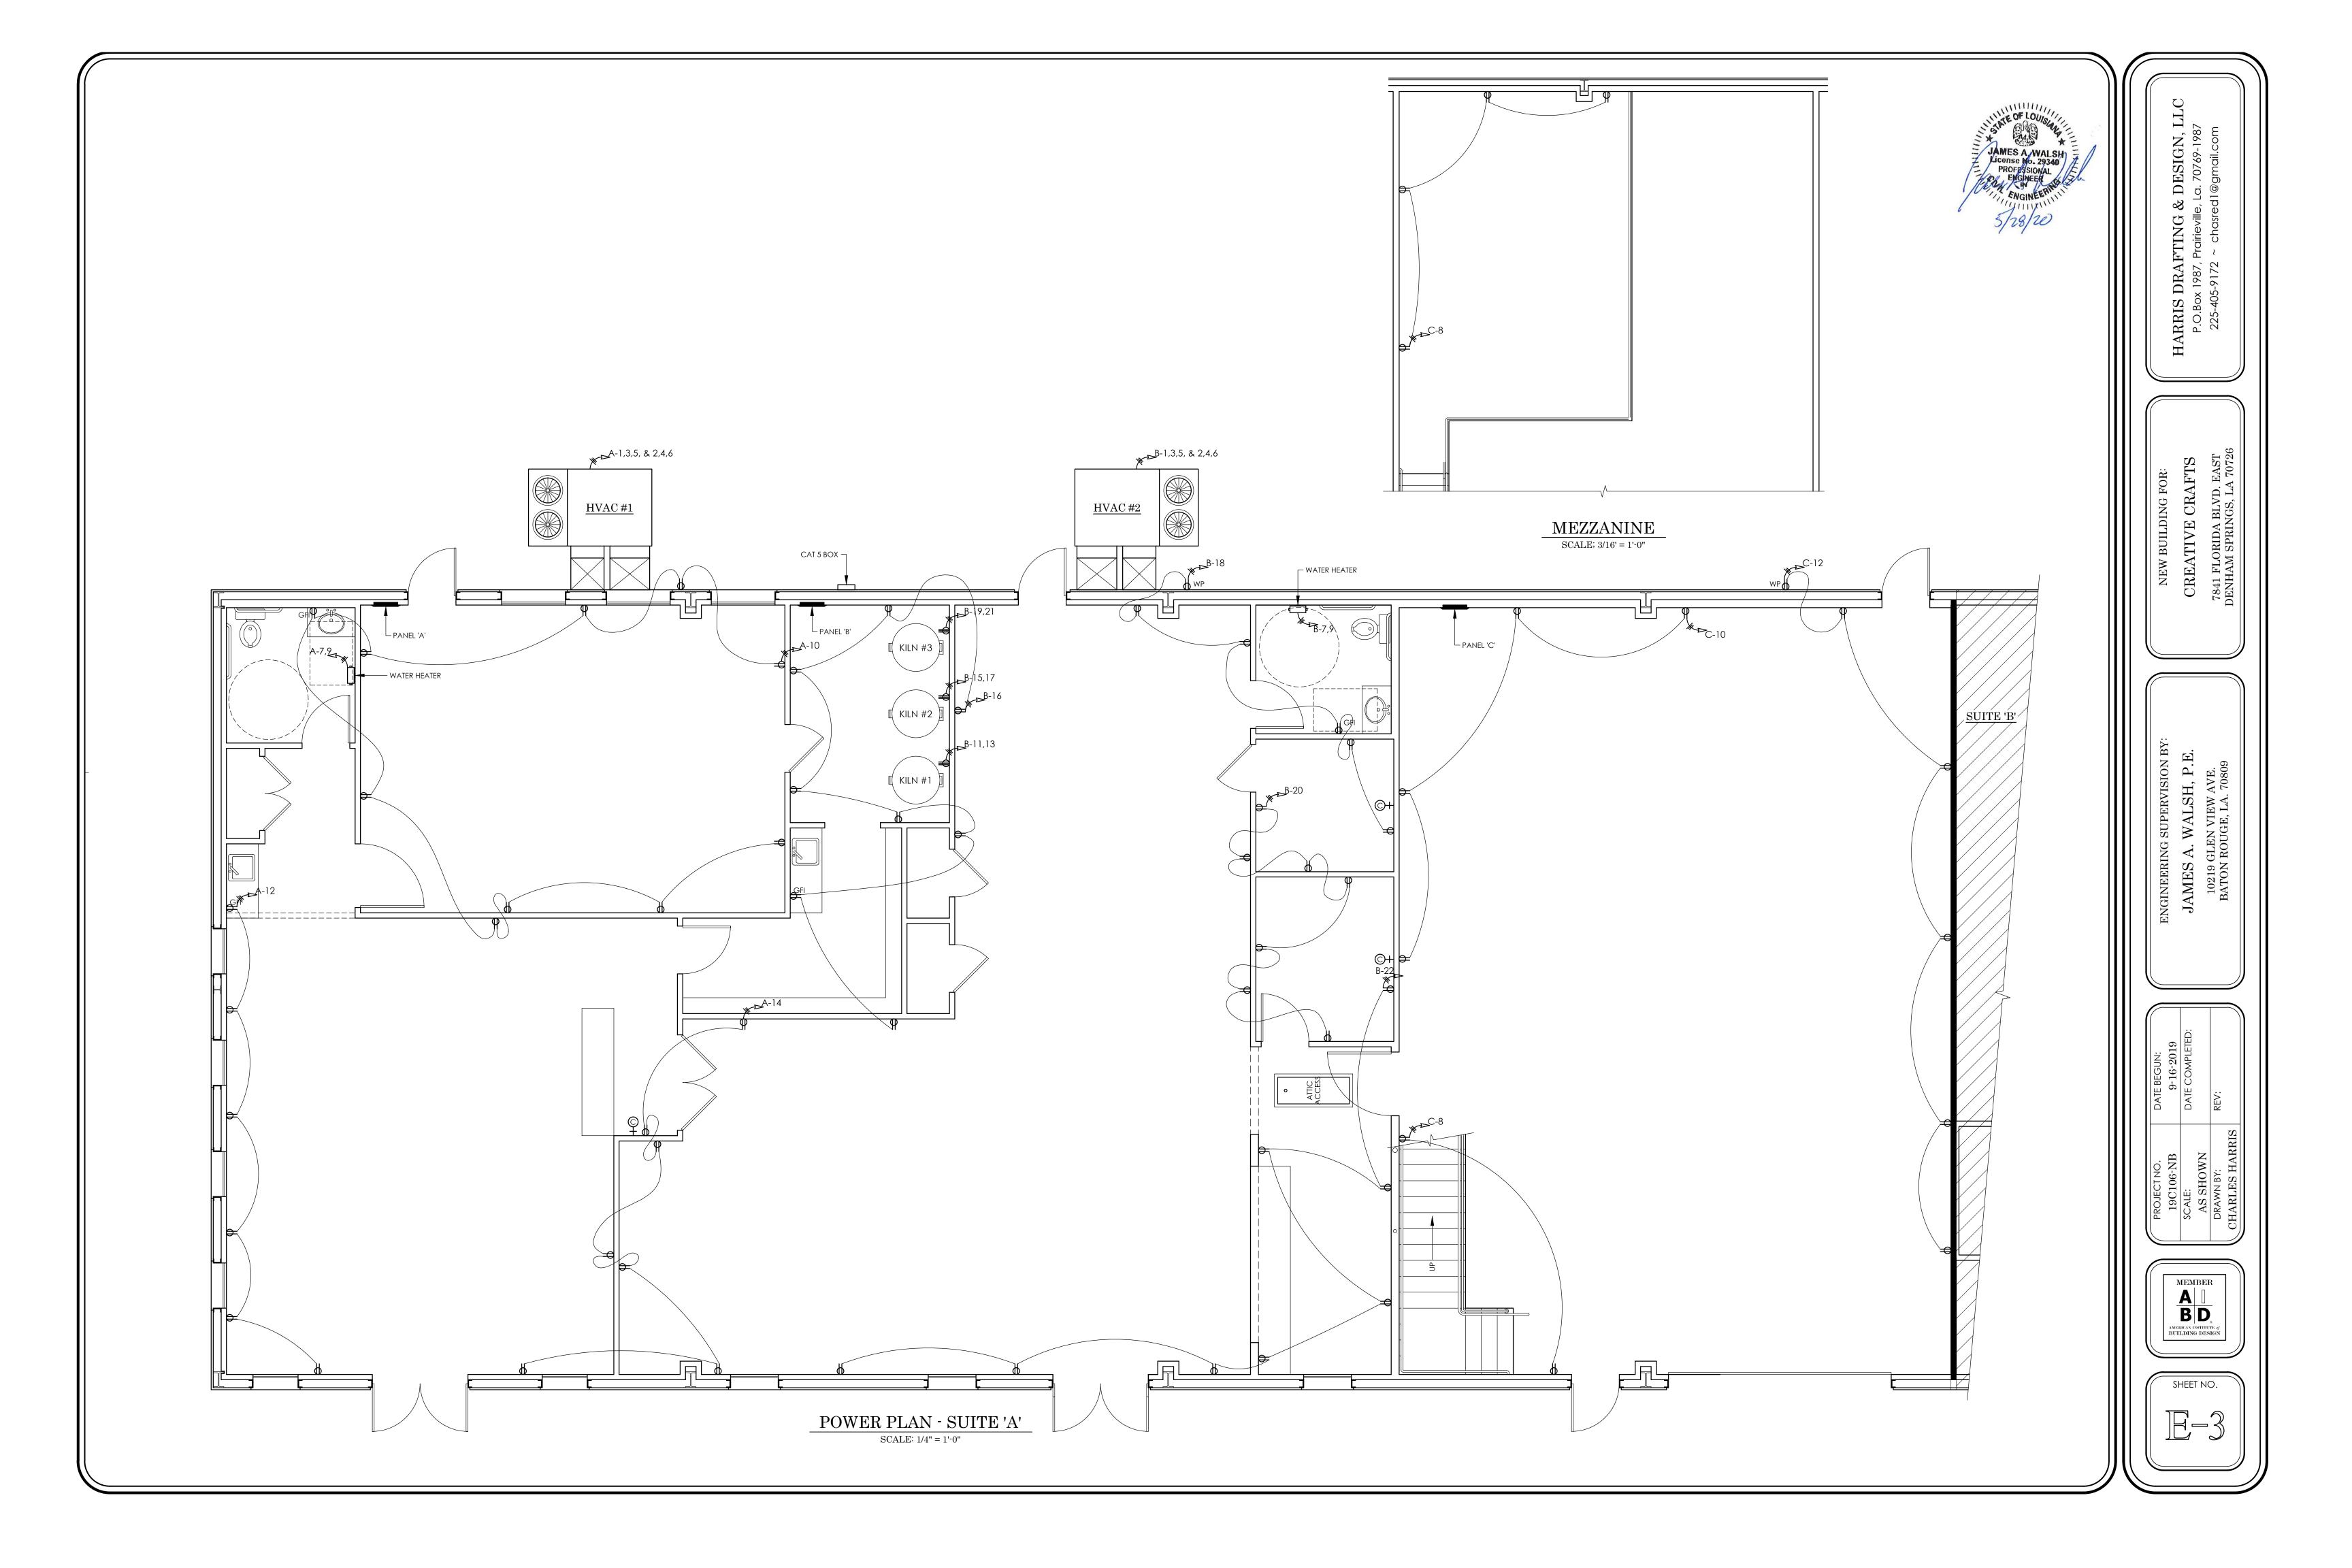

NEW BUILDING FOR: CREATIVE CRAFTS





PANEL "E" RISER
NOT TO SCALE

PANEL "D" RISER NOT TO SCALE


TO PANEL "A"


POWER DESCRIPTION CIR. AMP & S & S AMP CIR. POWER DESCRIPTION

WATER HEATER

7 20 20 8 RECEPTACLES
9 30 - 12 SPARE



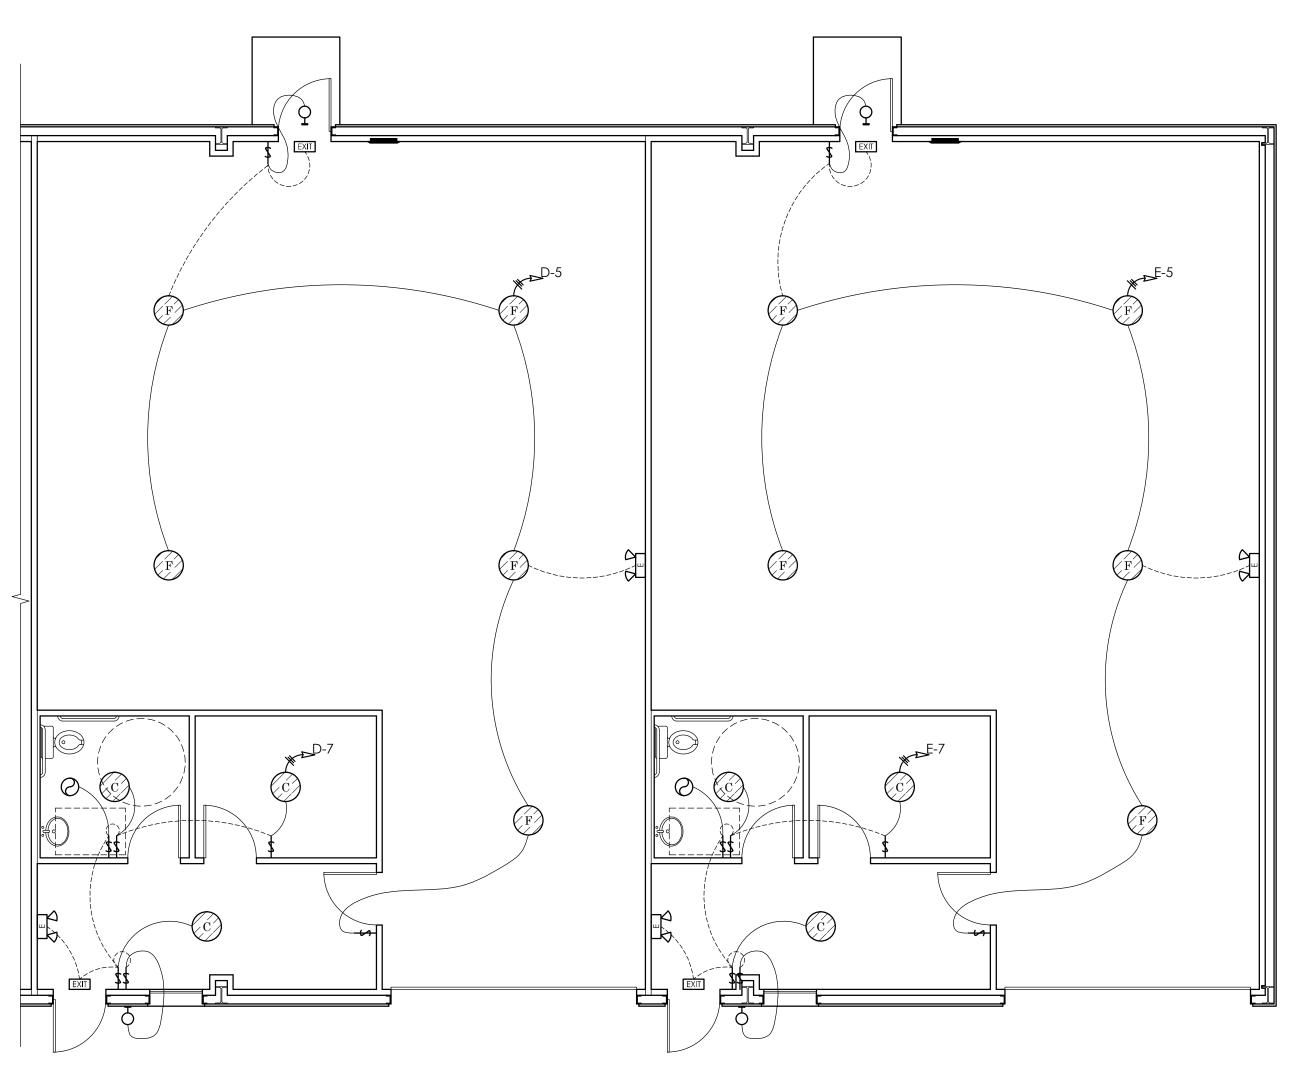

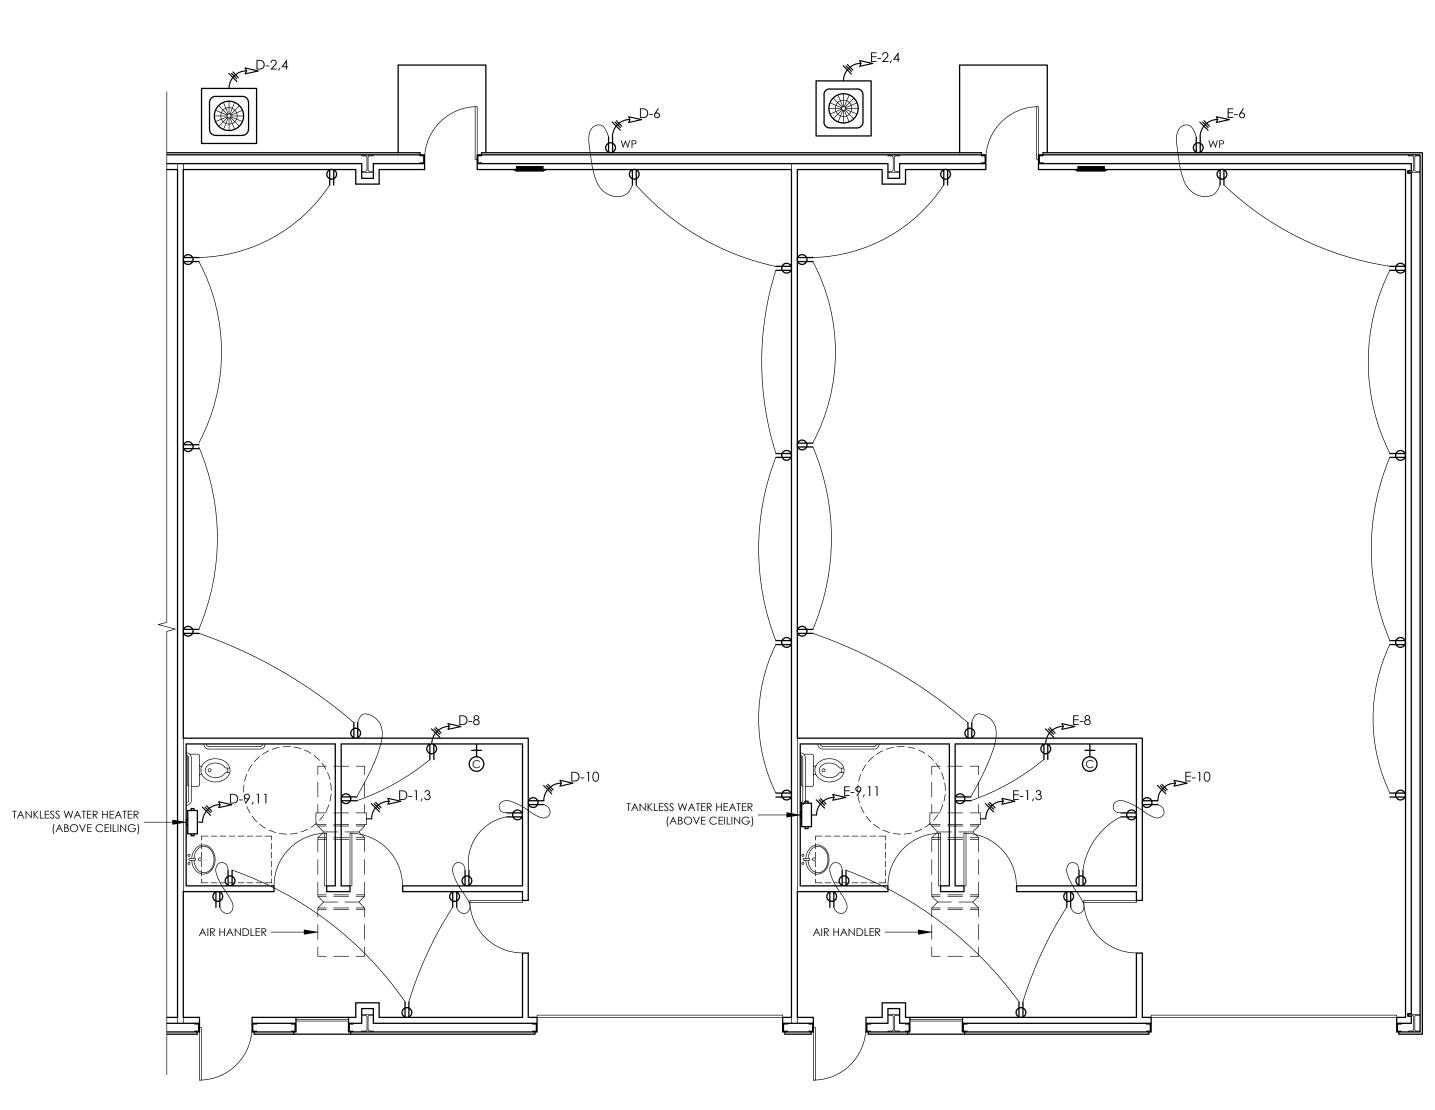


NOTE: AREA ABOVE LOBBY, OFFICE AND RESTROOM IS FLOORED TO RECEIVE AIR HANDLERS. SEE SECTION 'G' SHEET 'A-7'.


LIGHTING PLAN - SUITES 'D' & 'E'


SCALE: 3/16" = 1'-0"


POWER PLAN - SUITES 'D' & 'E'

SCALE: 3/16" = 1'-0"

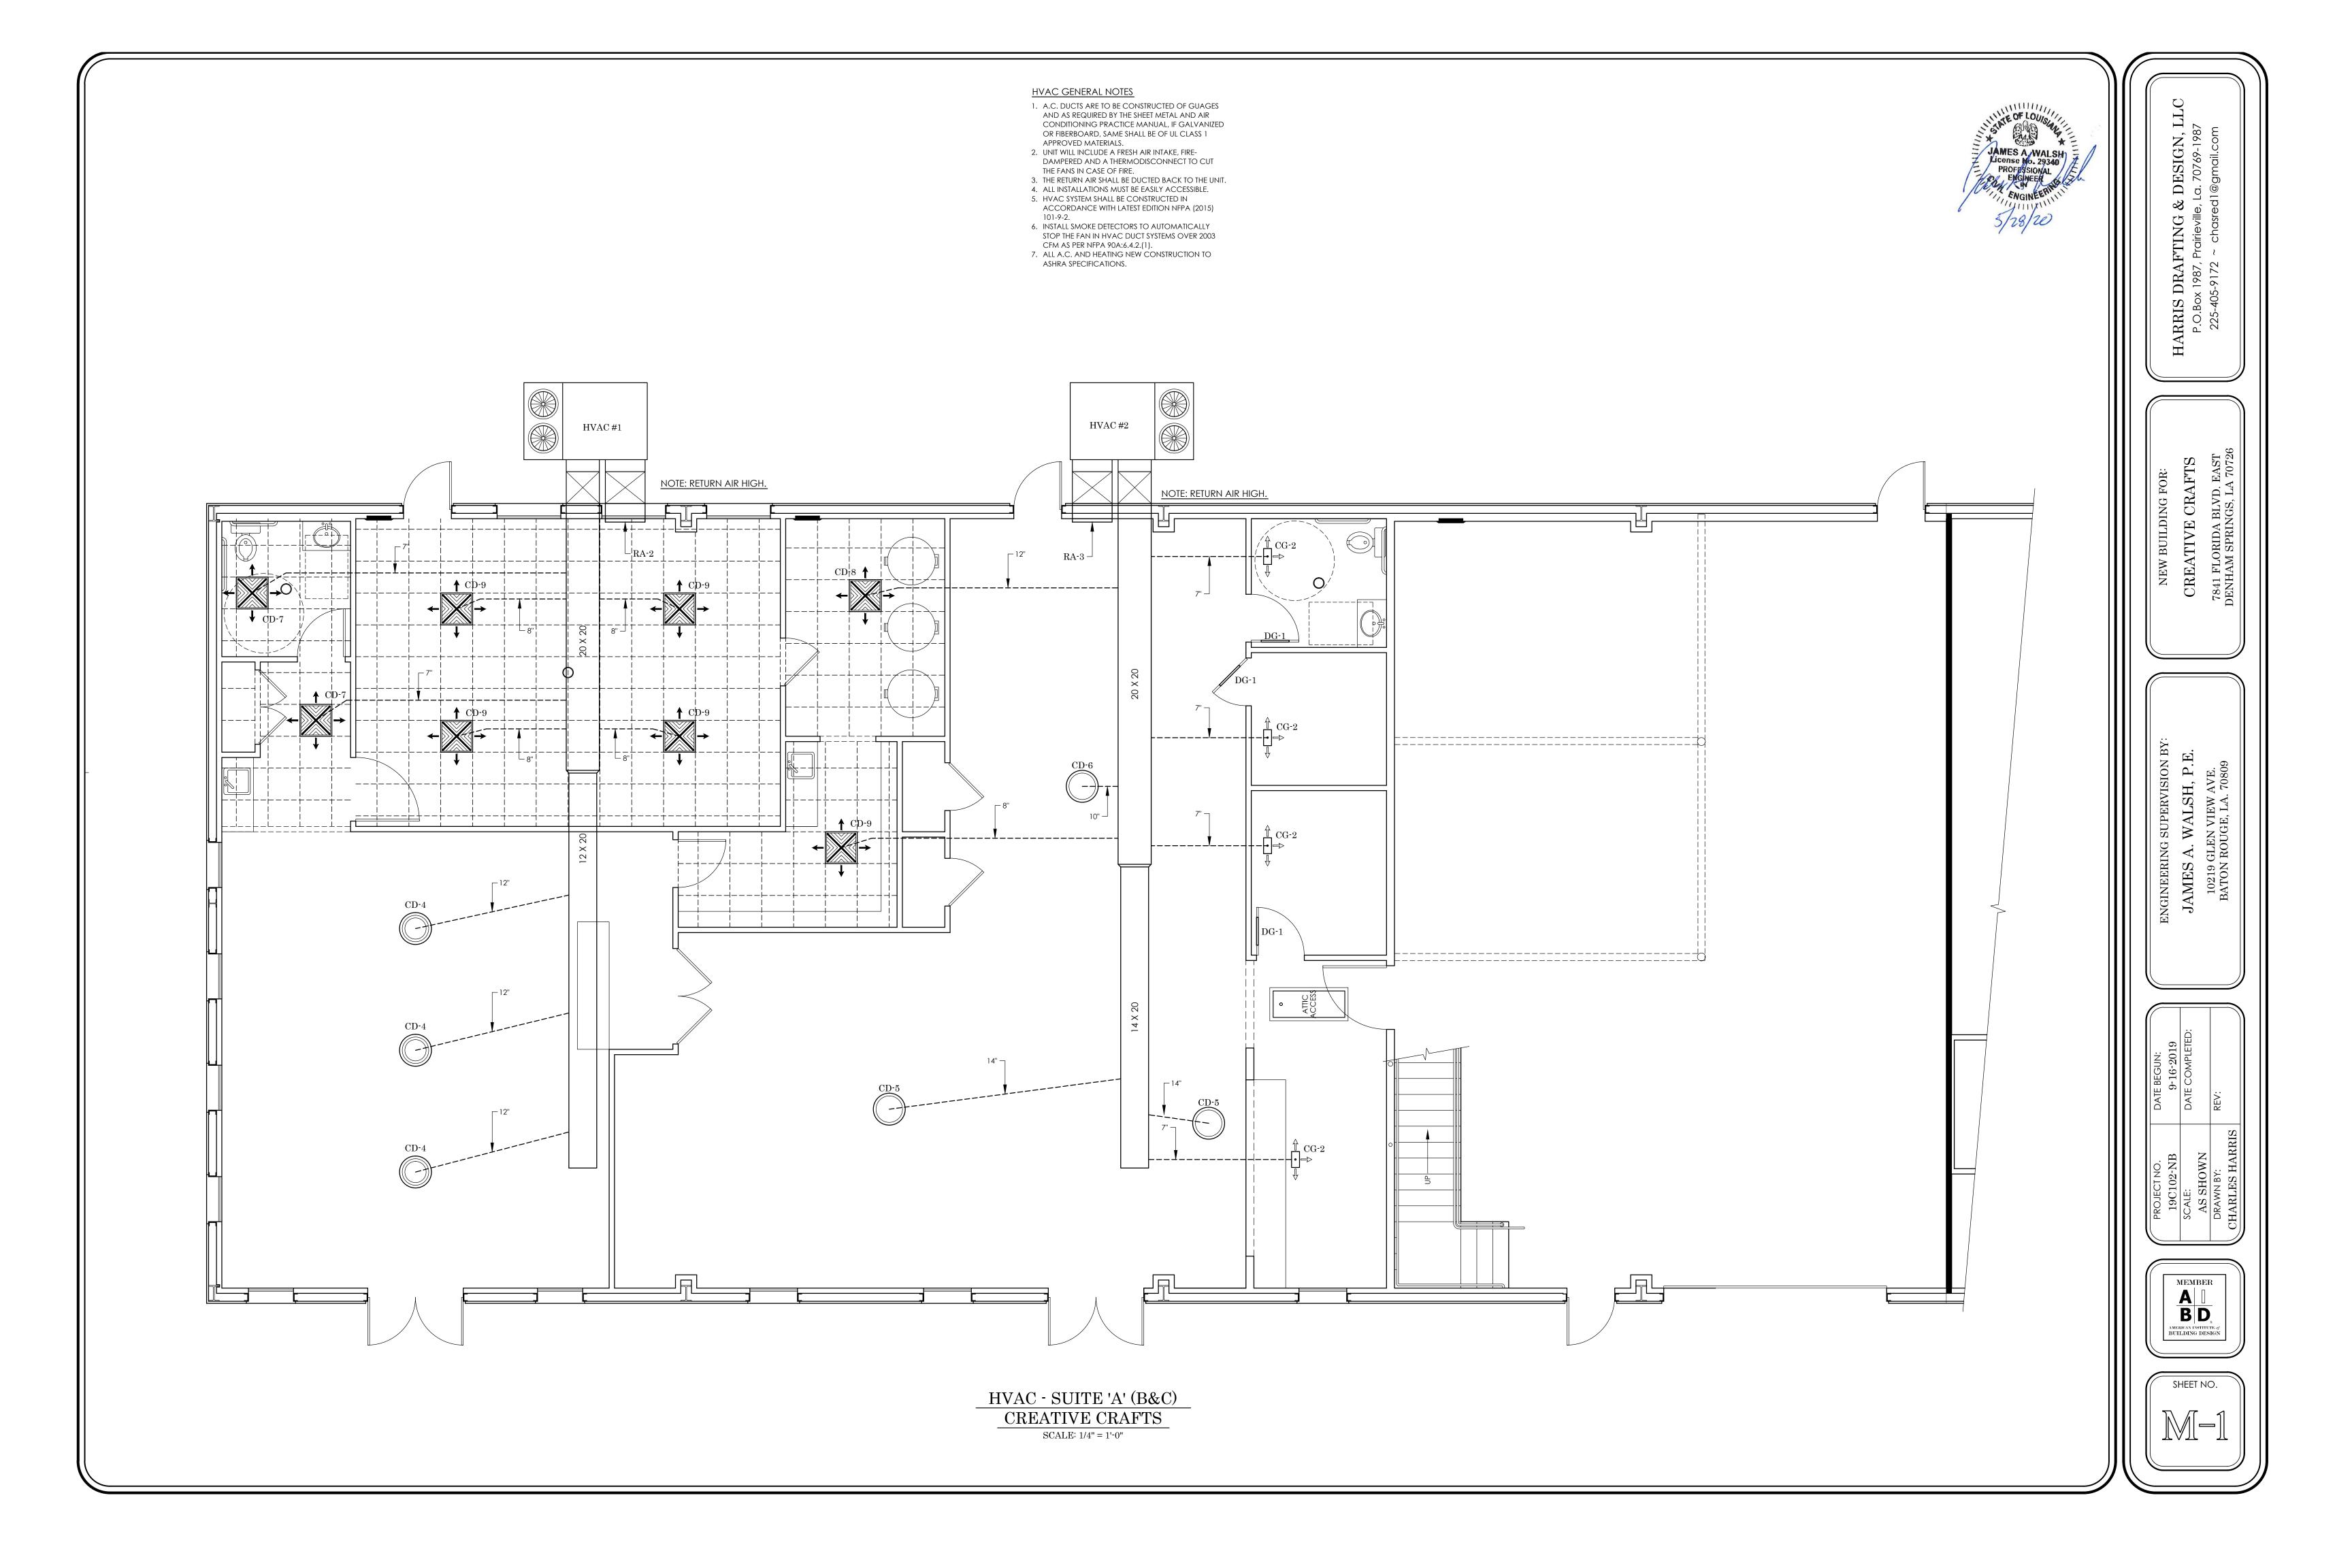

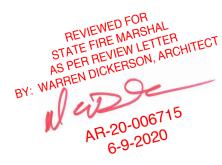


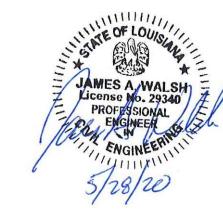

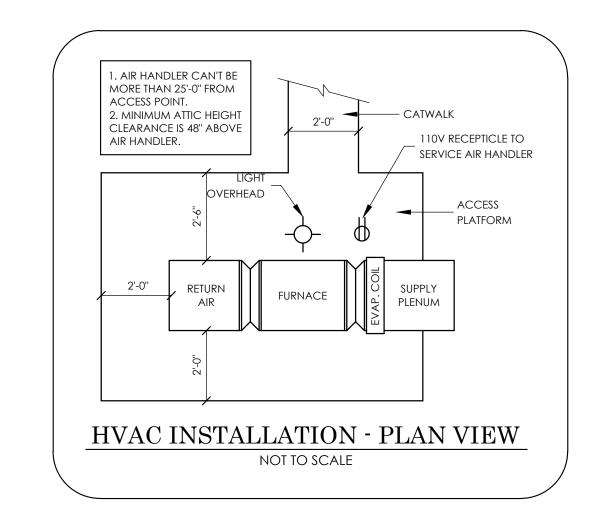


	HVAC EQUIPMENT SCHEDULE										
SYMBOL	MODEL	TONNAGE	HEAT	ELECTRICAL	AMPS	AIR HANDLER	MANUFACTURER				
A/C 1	DSC0720208VX-XA	6	20 KW ELECTRIC HEAT	208/230 3PH	MIN. 60 - MAX. 70		DAIKIN				
A/C 2	DSC0900203VX-XA	7.5	20 KW ELECTRIC HEAT	208/230 3PH	MIN. 90 - MAX. 100		DAIKIN				
A/C 4 & 5	G\$X160181AA	1.5	HKSC08XCAA 8 KW	208/230 1PH	COND. 20,AH 25	ARPF18B14AA	GOODMAN				


		Г	DIFFUSER & GRI	I E COUEDINE		
AAA DK	CITE		 		DECODIDION	AAANILIEA CTUDED
MARK	SIZE	CFM	MODEL	FRAME	DESCRIPTION	MANUFACTURER
CG1	12 X 12	200	LS4DA	SURFACE	CEILING GRILLE	METALAIRE
CG2	12 X 6	160	LS3DA	SURFACE	CEILING GRILLE	METALAIRE
CG3	12 X 12	160	LS4DA	SURFACE	CEILING GRILLE	METALAIRE
CG4	10 X 6	100	LS3DA	SURFACE	CEILING GRILLE	METALAIRE
CD4	12"	600	3000	SURFACE	ROUND CEILING DIFFUSER	METALAIRE
CD5	14"	750	3000	SURFACE	ROUND CEILING DIFFUSER	METALAIRE
CD6	10"	400	3000	SURFACE	ROUND CEILING DIFFUSER	METALAIRE
CD7	7''	160	5800	LAYIN	CEILING GRILLE	METALAIRE
CD8	12"	400	5800	LAYIN	CEILING GRILLE	METALAIRE
CD9	8"	200	5800	LAYIN	CEILING GRILLE	METALAIRE
DG1	16 X 16		DGDF	DOOR GRILLE	DOOR GRILLE	METALAIRE
RA-1	20 X20		RHF	SURFACE	FILTER BACK GRILLE	METALAIRE
RA-2	30 X 30		RH	SURFACE	RETURN GRILLE	METALAIRE
RA-3	36 X 36		RH	SURFACE	RETURN GRILLE	METALAIRE

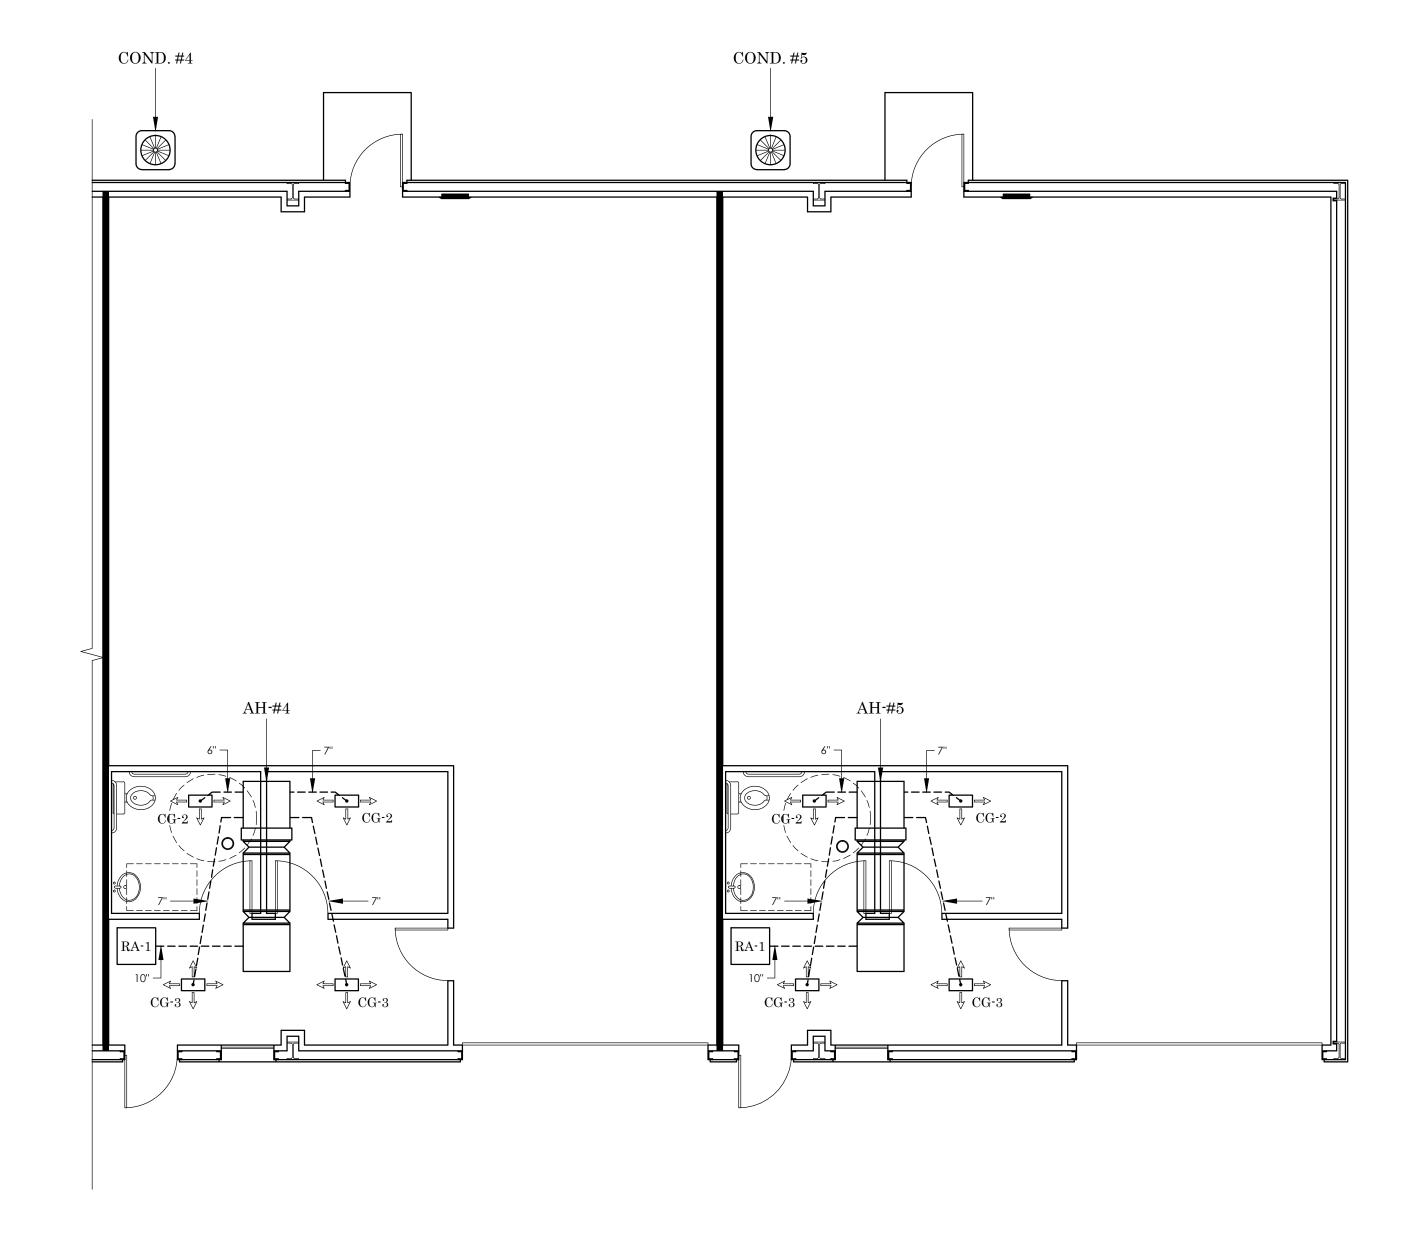


HVAC PLAN - SUITES 'D' & 'E' SCALE: 3/16" = 1'-0"

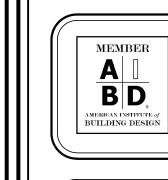

NEW BUILDING FOR:
CREATIVE CRAFTS
7841 FLORIDA BLVD. EAST
DENHAM SPRINGS, LA 70726

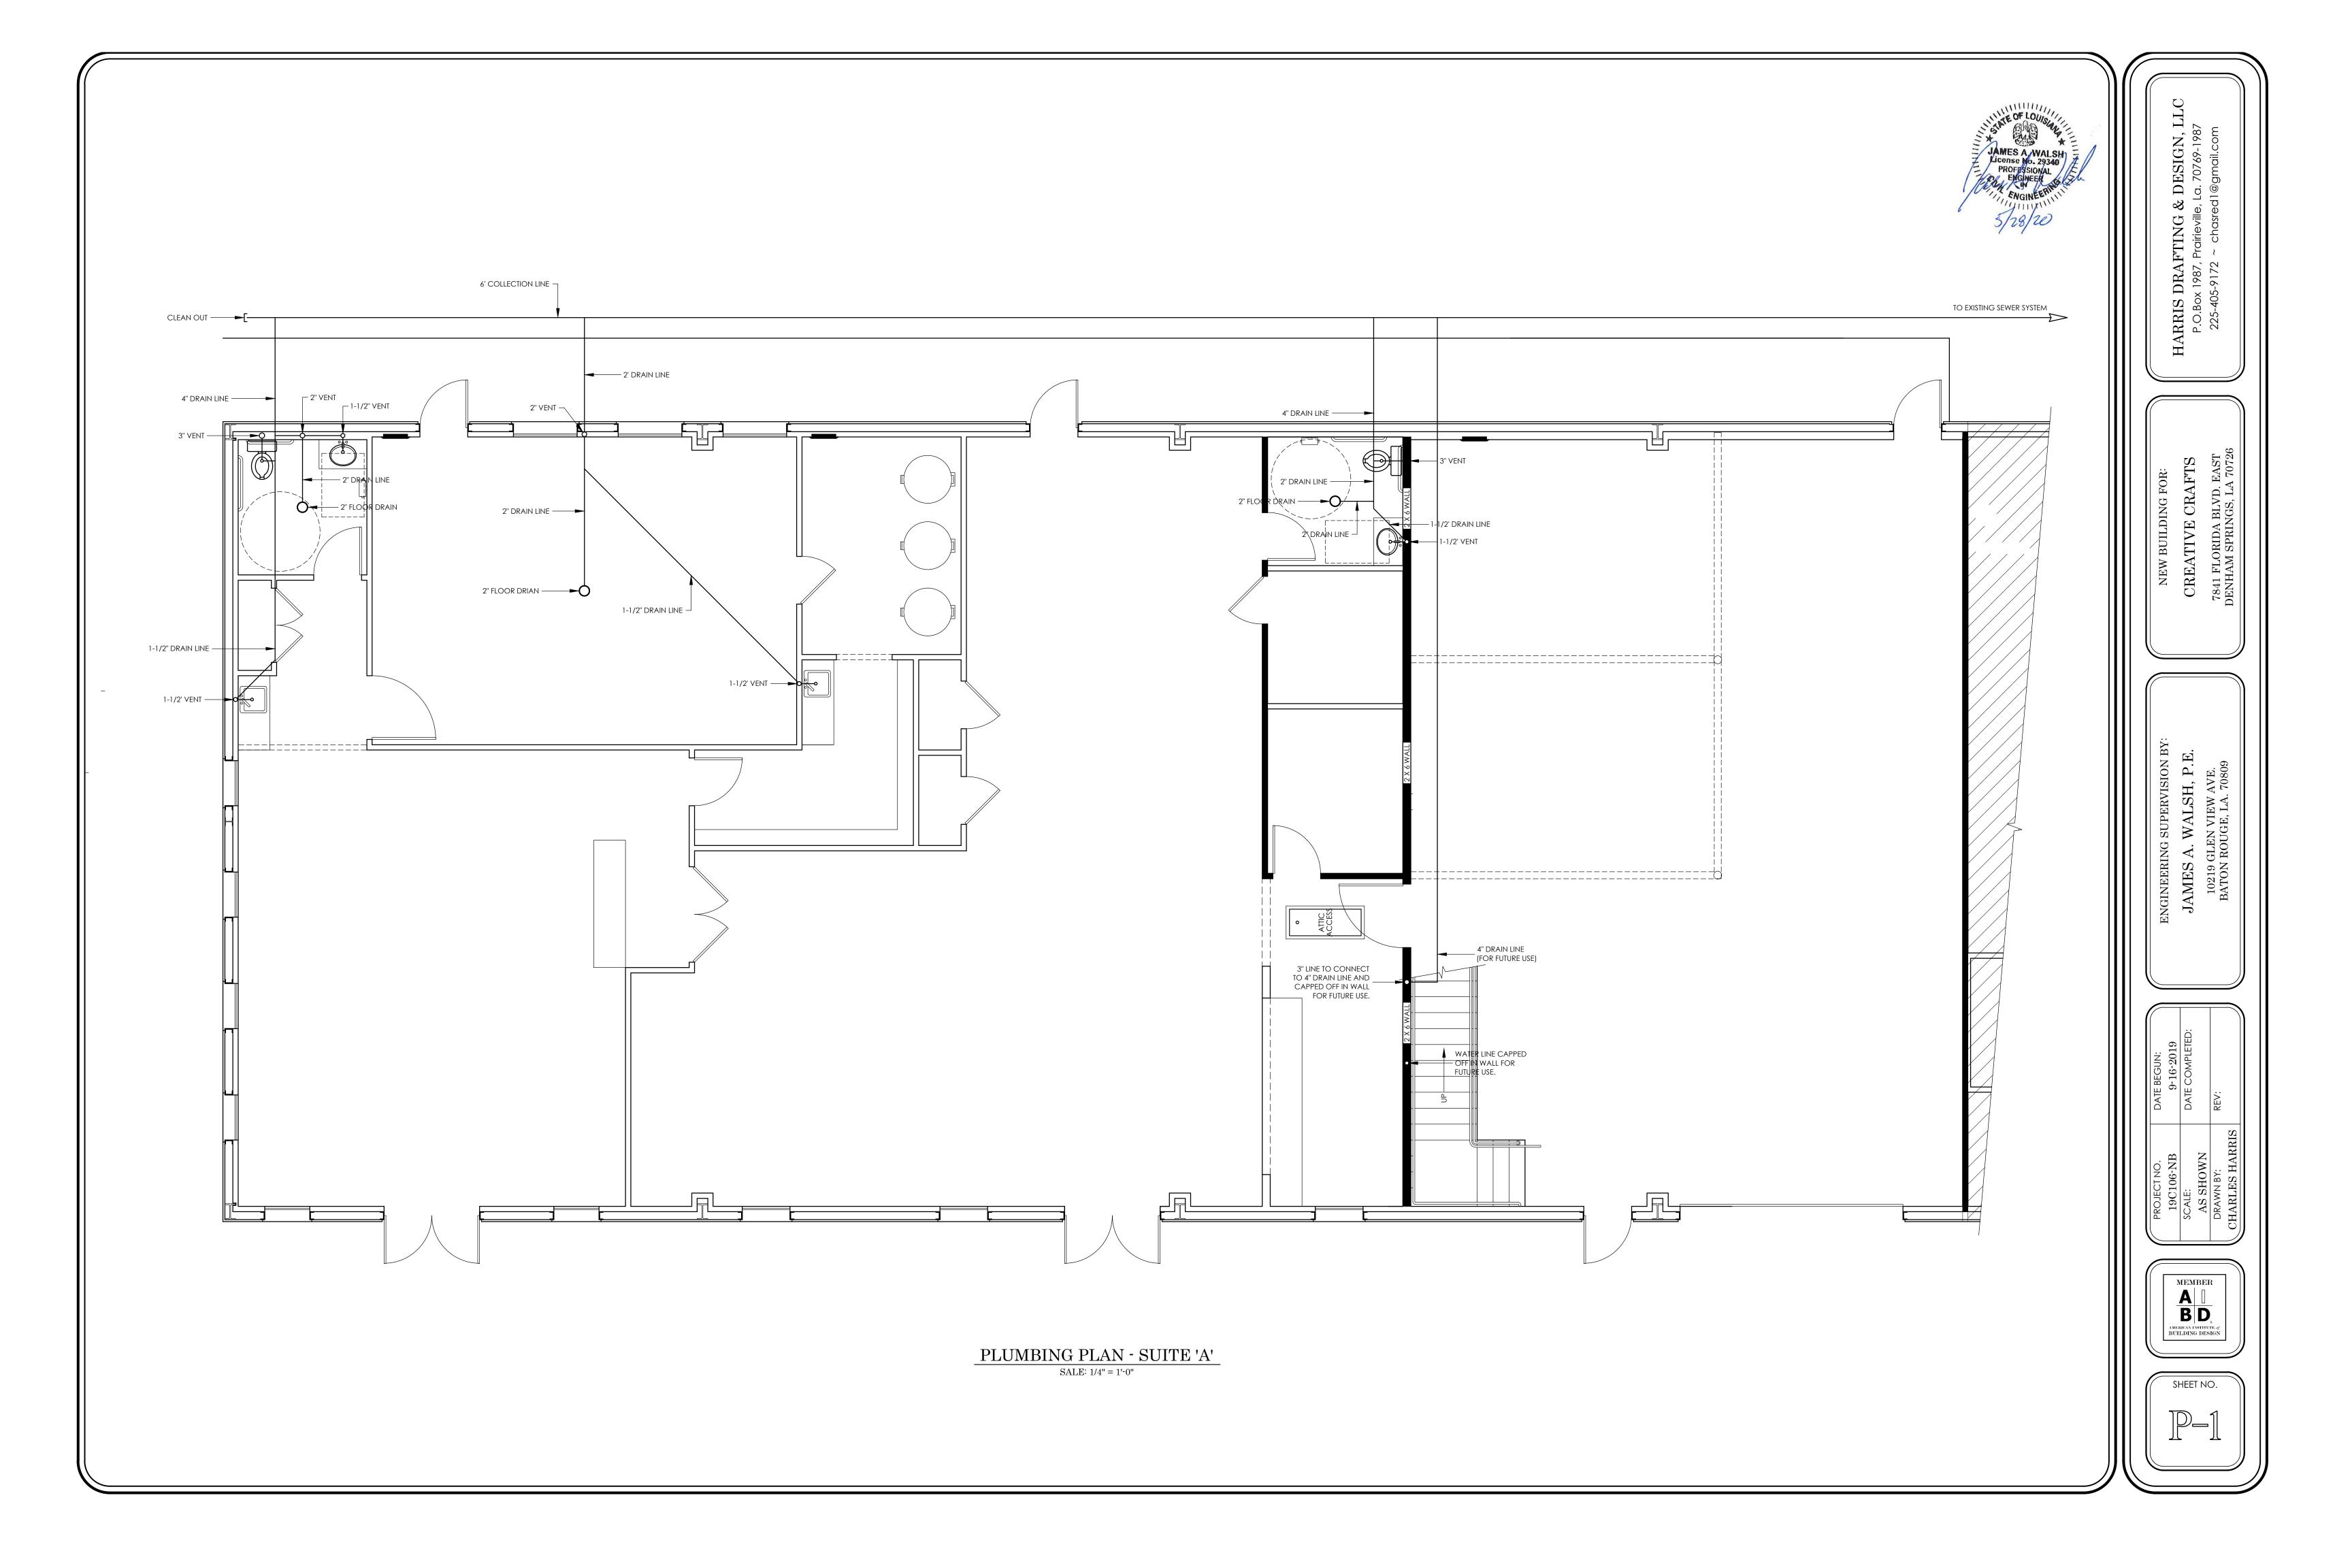

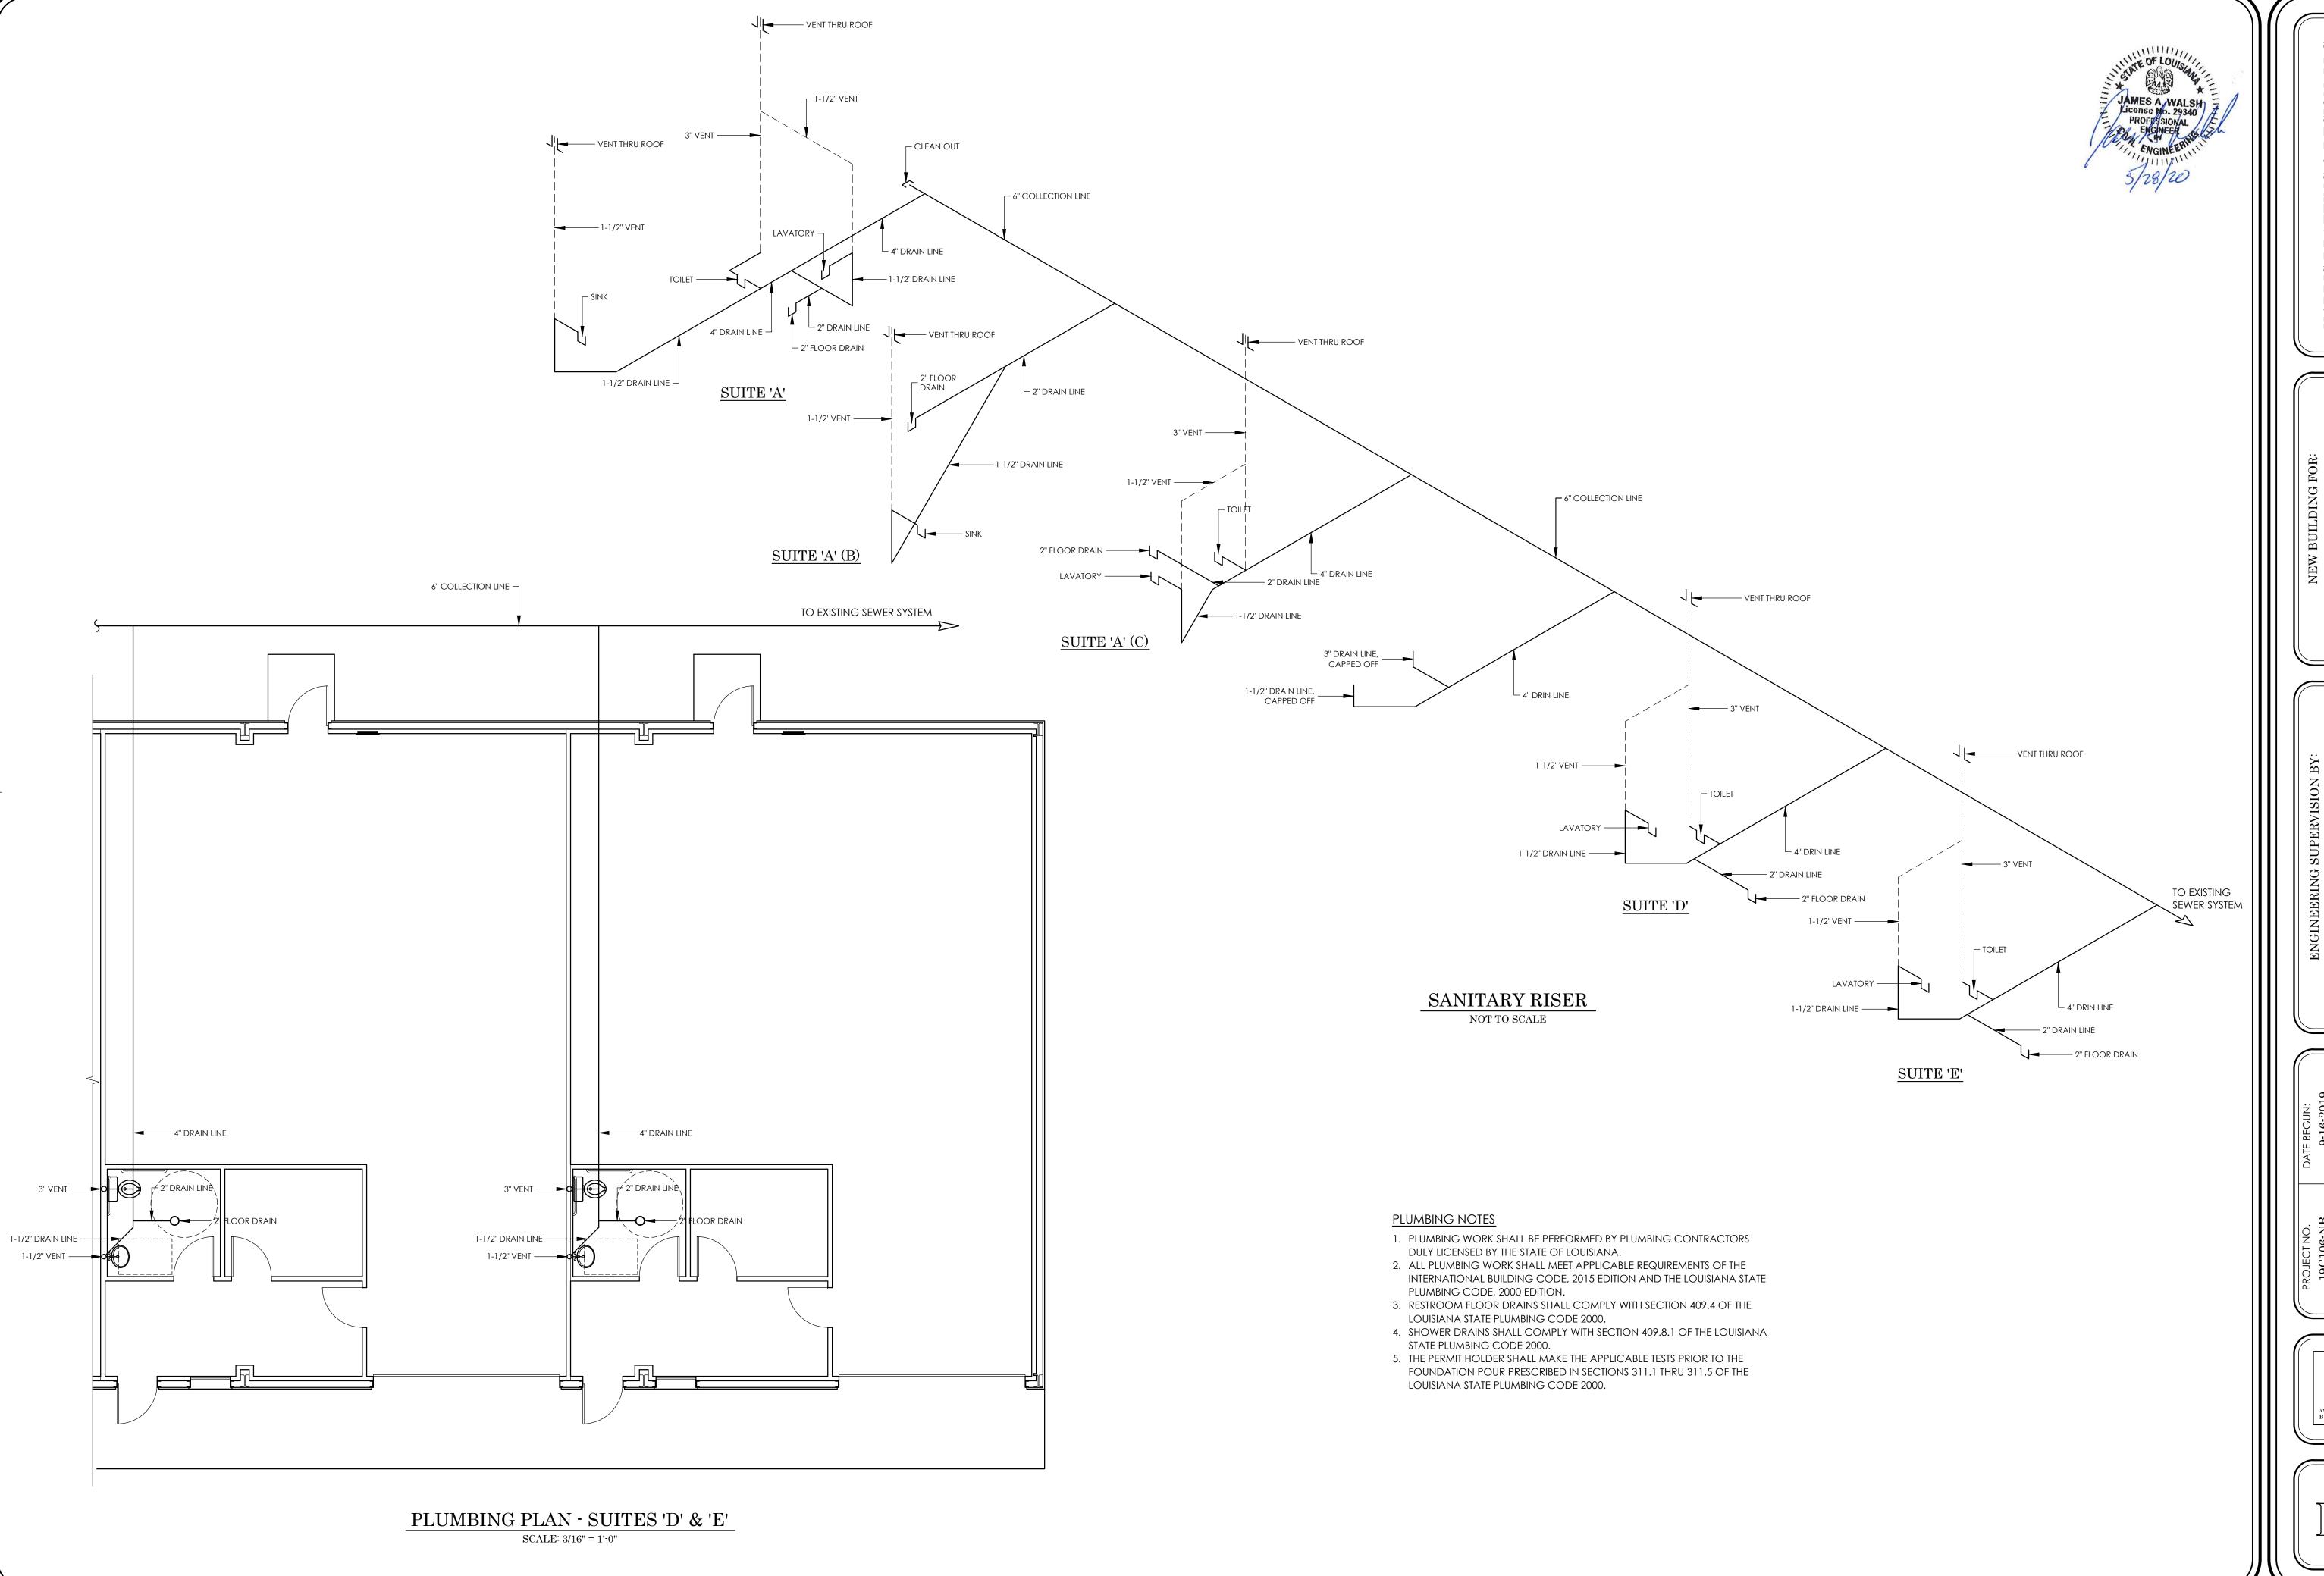

HARRIS DRAFTING & DESIGN, LLC P.O.Box 1987, Prairieville, La. 70769-1987 225-405-9172 ~ chasred1@gmail.com

CREATIVE CRAFTS
7841 FLORIDA BLVD. EAST
DENHAM SPRINGS, LA 70726

JAMES A. WALSH, P.E.

10219 GLEN VIEW AVE.


BATON ROUGE, LA. 70809

19C106-NB 9-16-2019
SCALE: DATE COMPLETED:
AS SHOWN
DRAWN BY: REV:
HARLES HARRIS



SHEET NO.

[P-2]

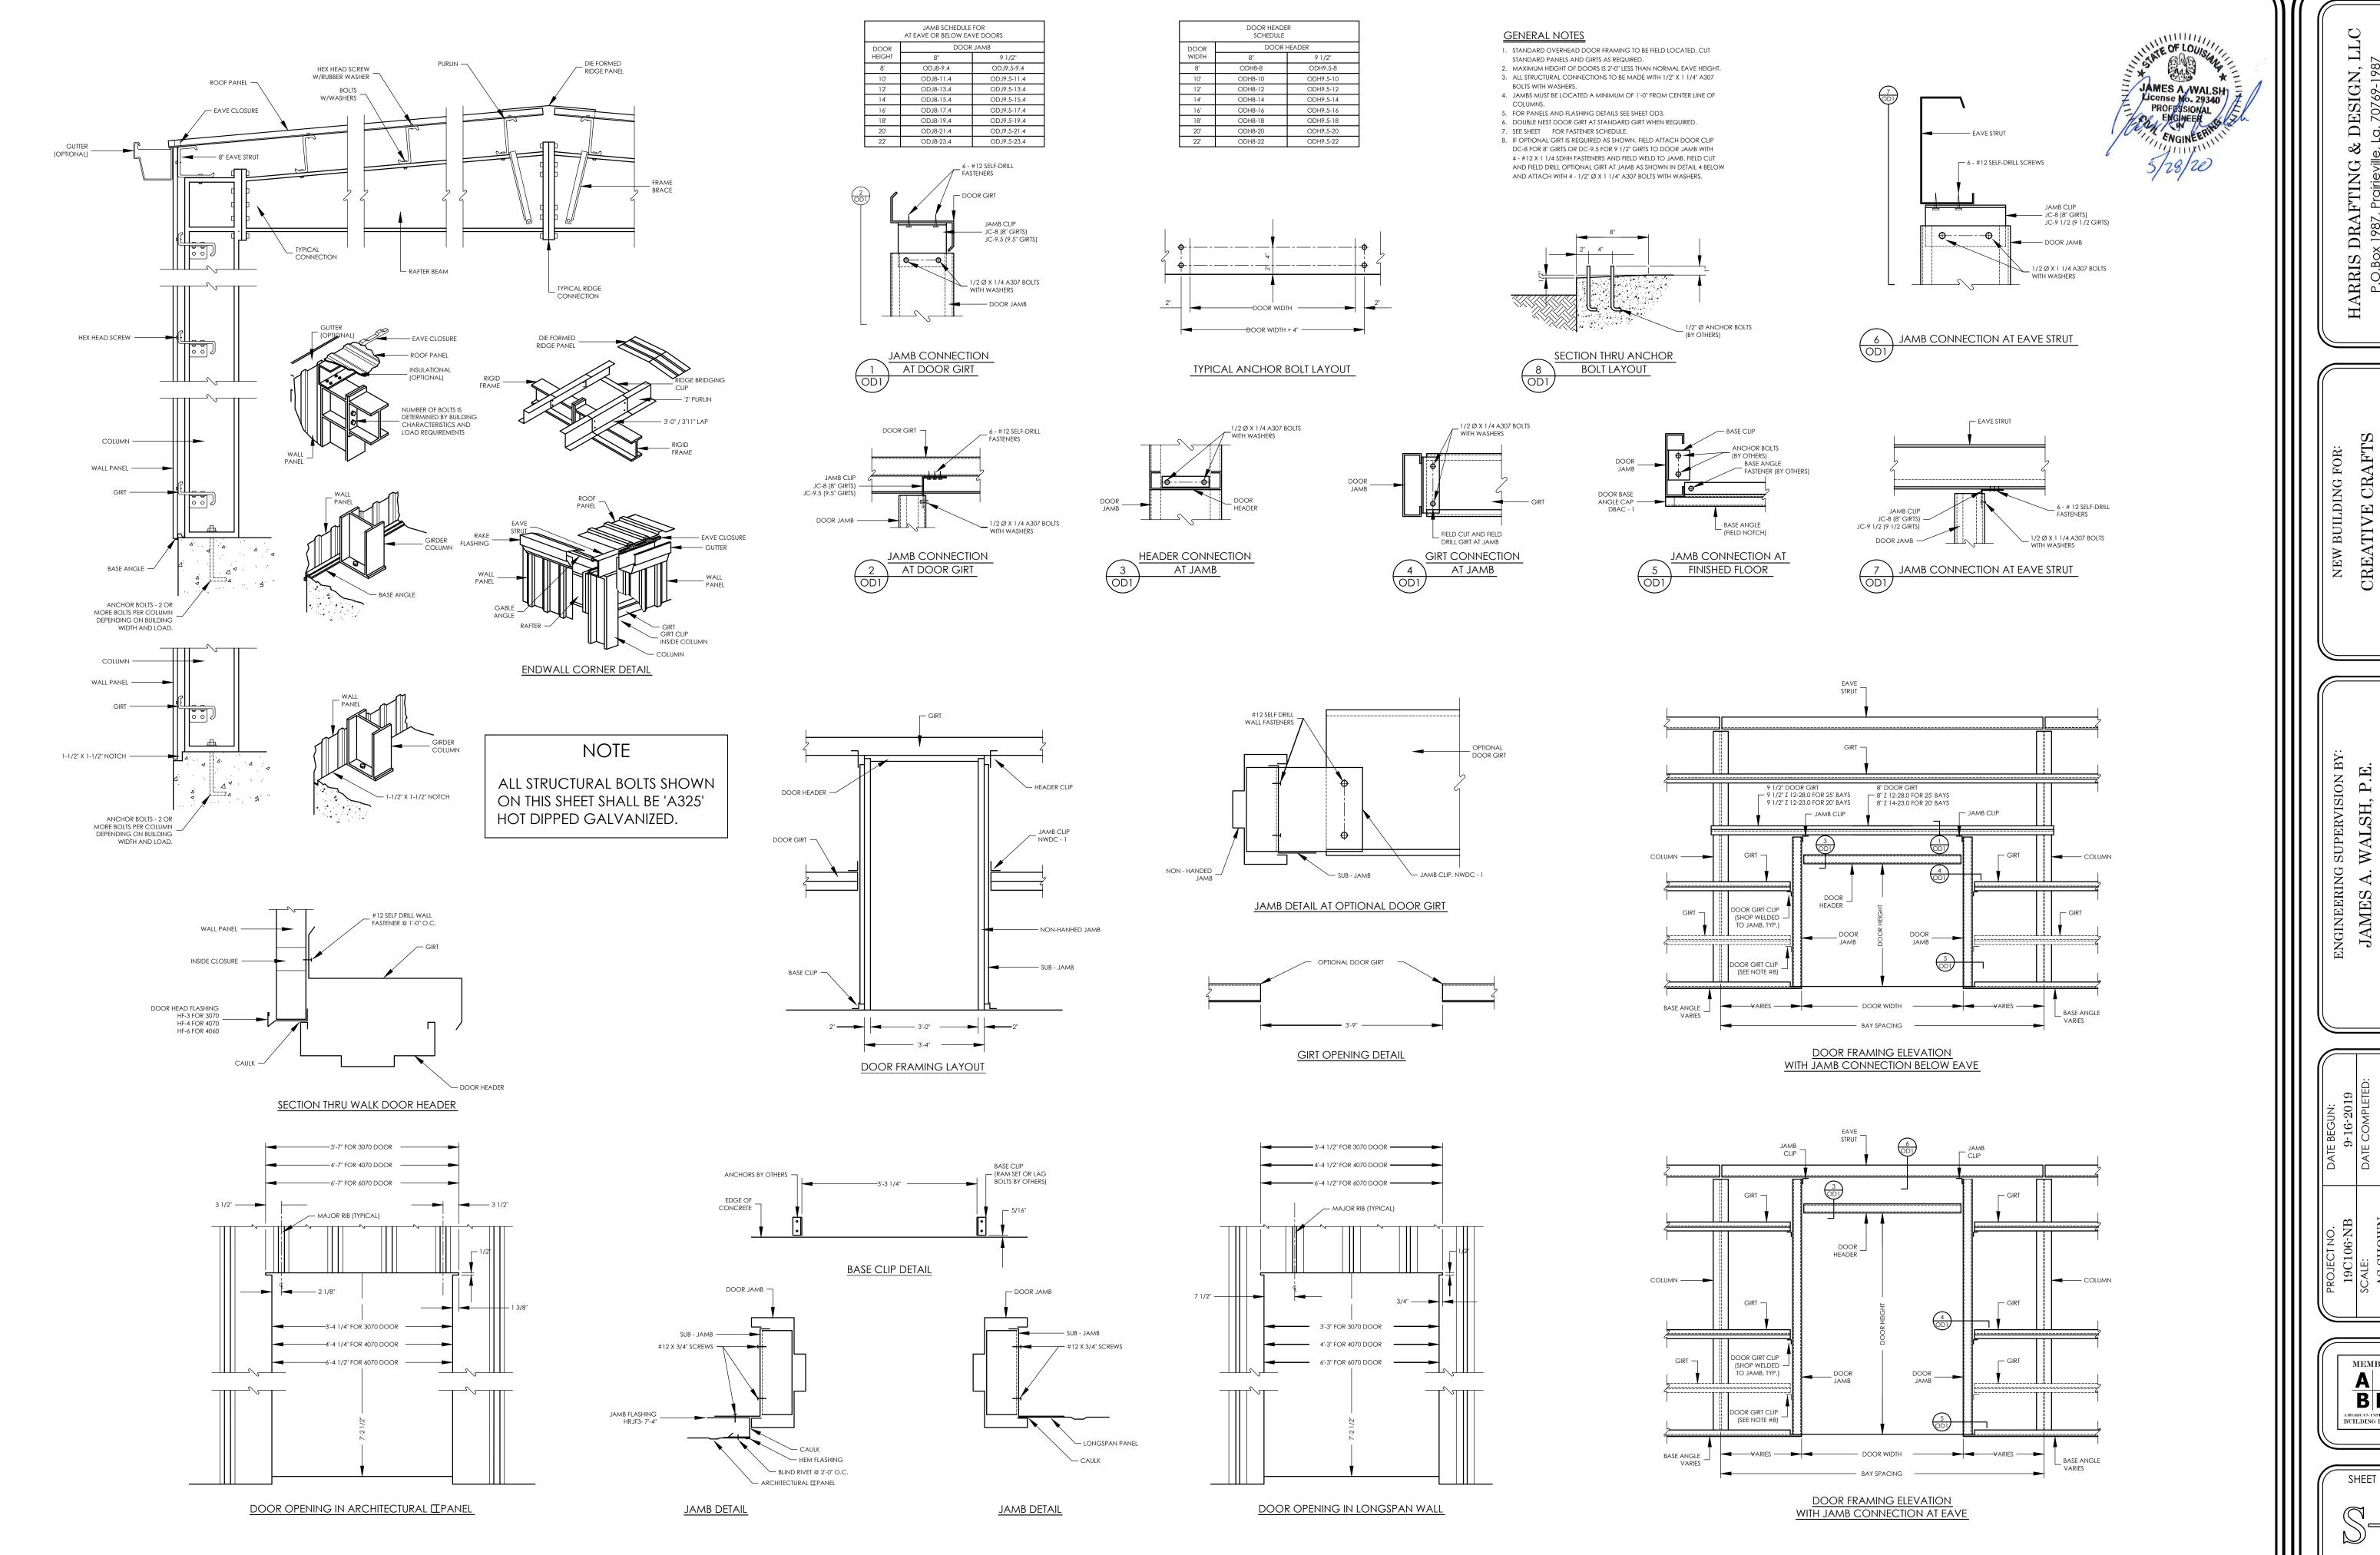

DRAFTING 8 DX 1987, Prairieville 72 ~ 225-673-4688 [ARRIS D P.O.Box 3



SHEET NO.

